



# LANDING AT YALE

316 A, 316 B, 316 C, 316 D, 316 E, 316 F, 316 G, 316 I, 316 J,  
316 K, 316 L, 316 M, 316 N & 316 O THORTON ROAD  
4605 A, 4605 B, 4605 C, 4605 D, 4605 E, 4605 F, 4605 G, 4605 H,  
4605 I, 4605 J, 4605 K & 4605 L YALE STREET  
HOUSTON, TEXAS

**D&Q**  
design

16018 AUTUMN FALLS LN.  
HOUSTON, TEXAS 77095  
MOBILE: (281) 818-5609








**D&Q**  
design  
16018 AUTUMNFALLS LN.  
HOUSTON, TEXAS 77055  
PHONE & FAX: (281) 815-3269  
MOBILE: (281) 815-5609

MARK	DATE	DESCRIPTION
A	02/21/22	ISSUED FOR COH

LANDING AT YALE  
316 A, 316 B, 316 C, 316 D, 316 E, 316 F, 316 G,  
316 H, 316 I, 316 J, 316 K, 316 L, 316 M, 316 N,  
& 316 O THORNTON ROAD, 4605 A, 4605 B,  
4605 C, 4605 D, 4605 E, 4605 F, 4605 G, 4605 H,  
4605 I, 4605 J, 4605 K & 4605 L YALE STREET  
HOUSTON, TEXAS.

SHEET TITLE  
**SITE PLAN**

SHEET NO.  
**A0.1**

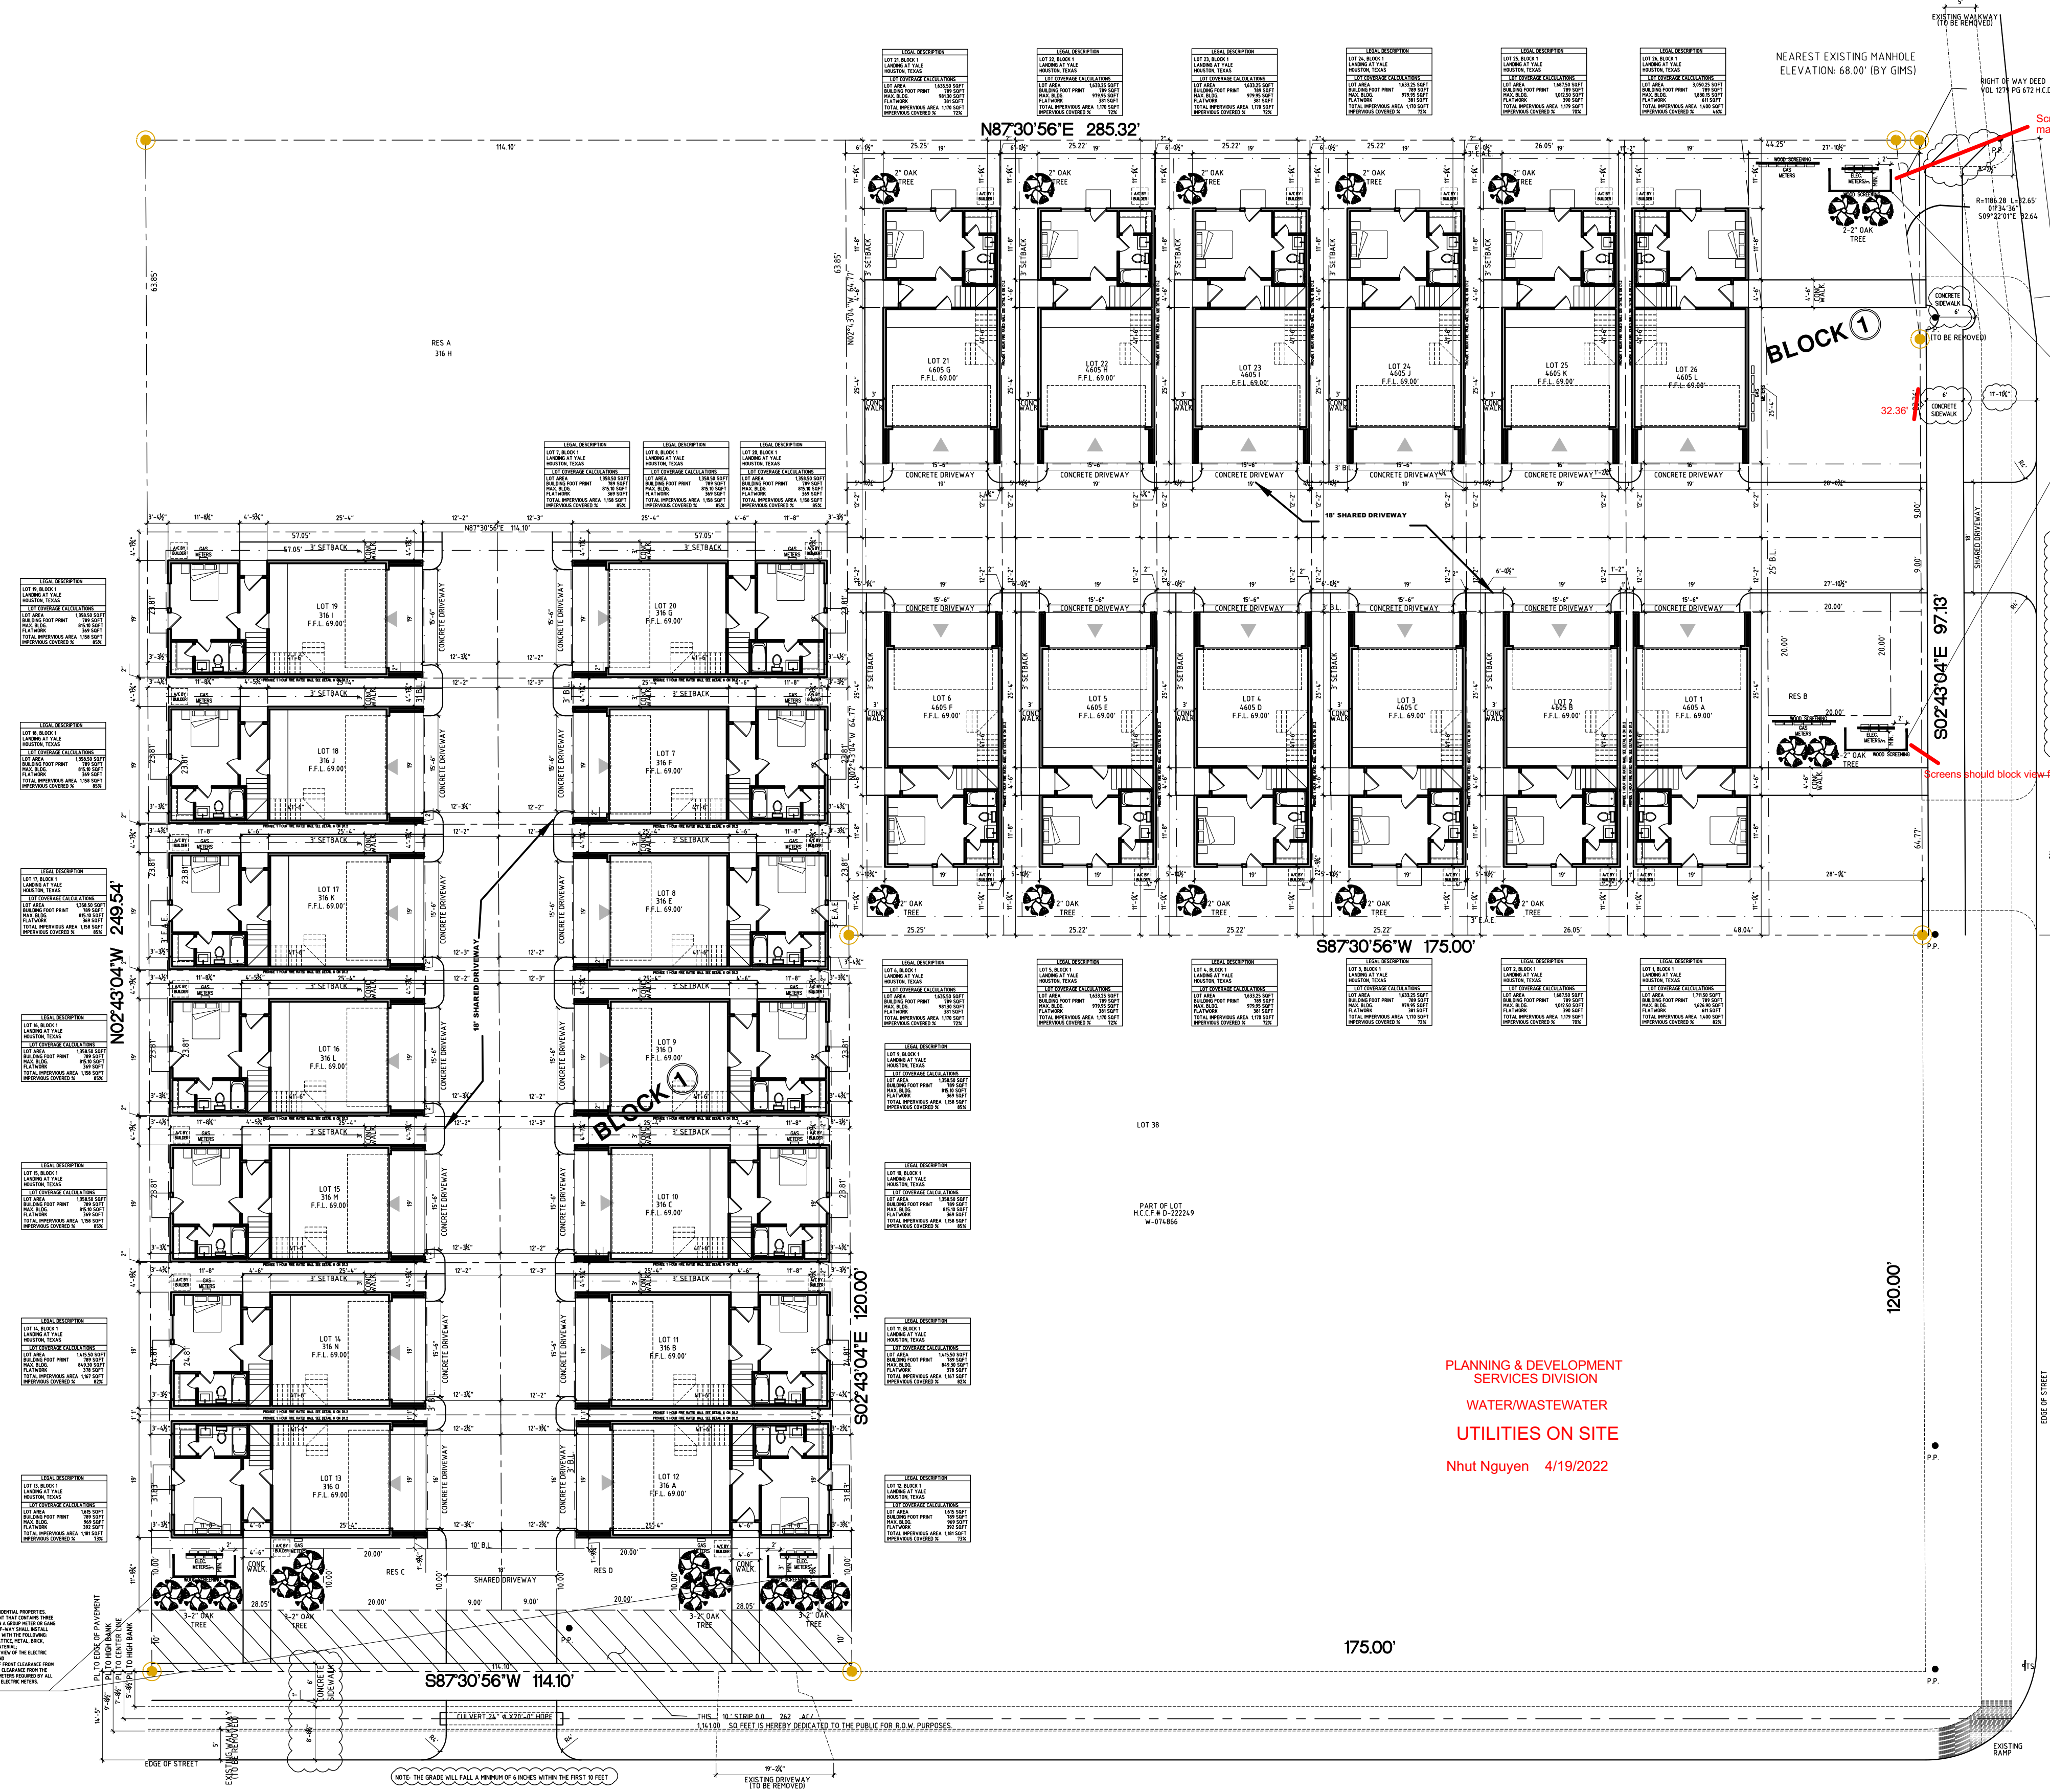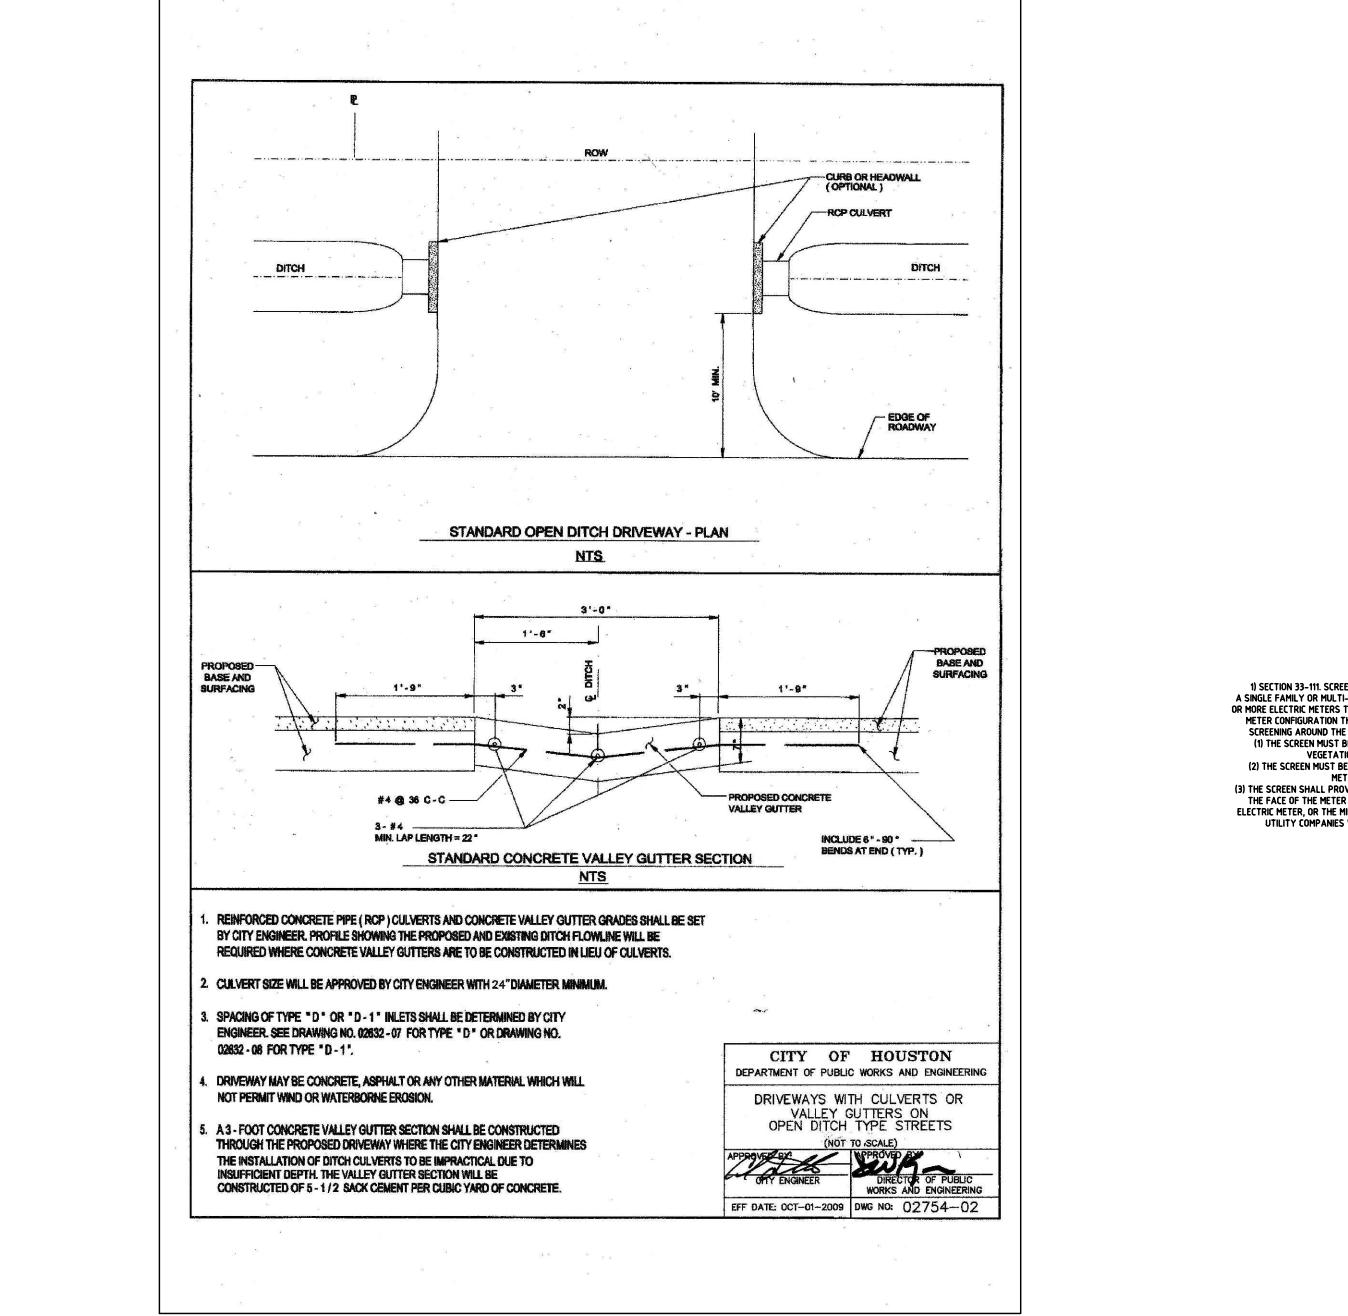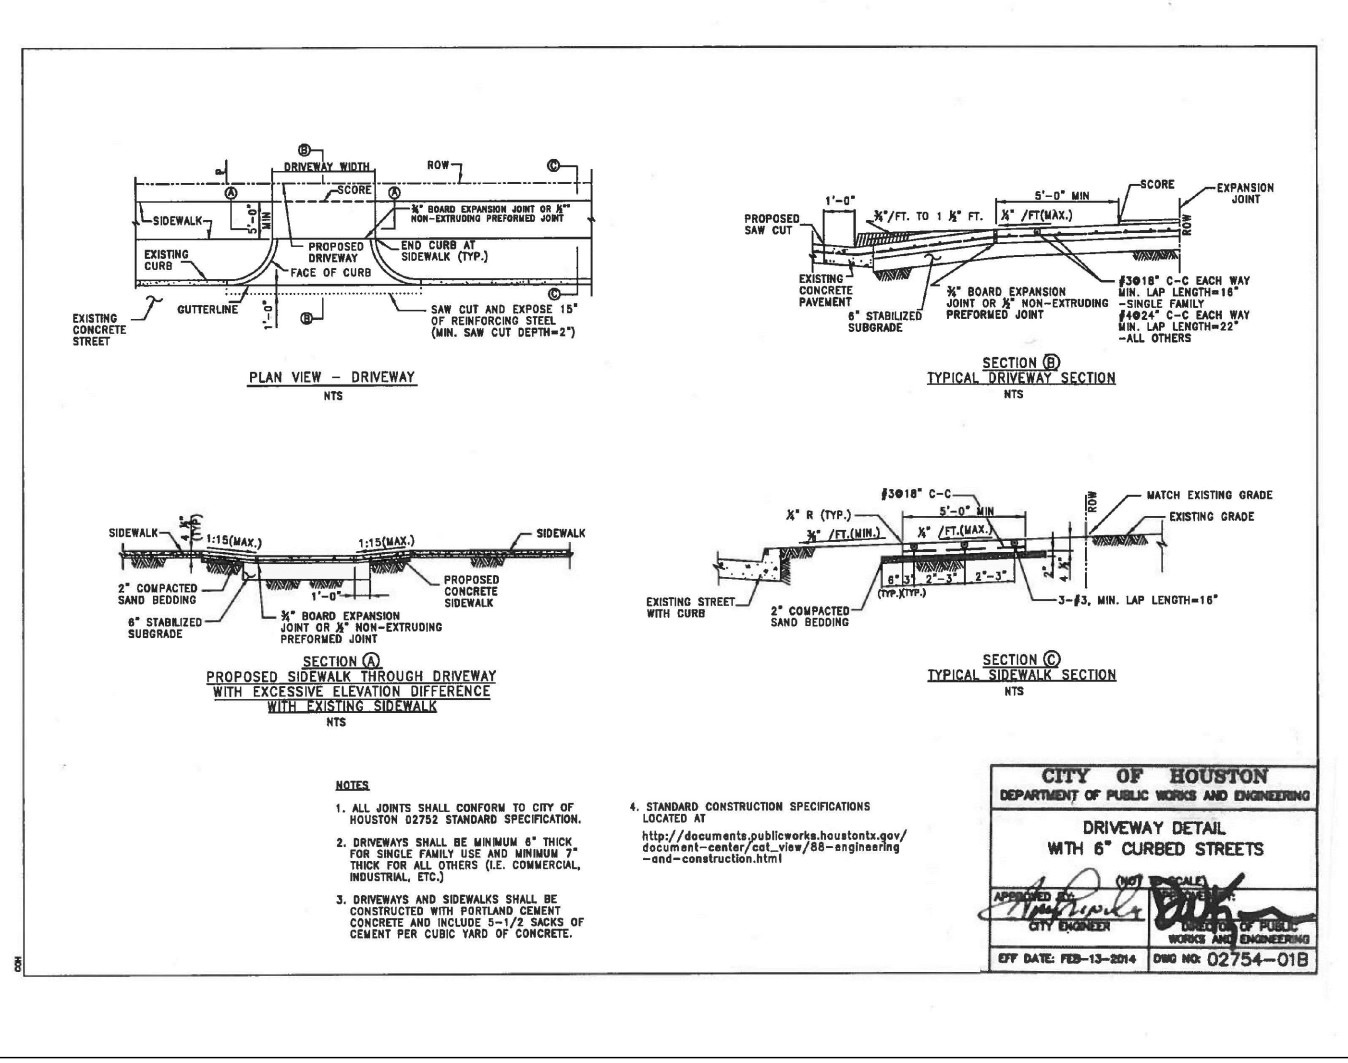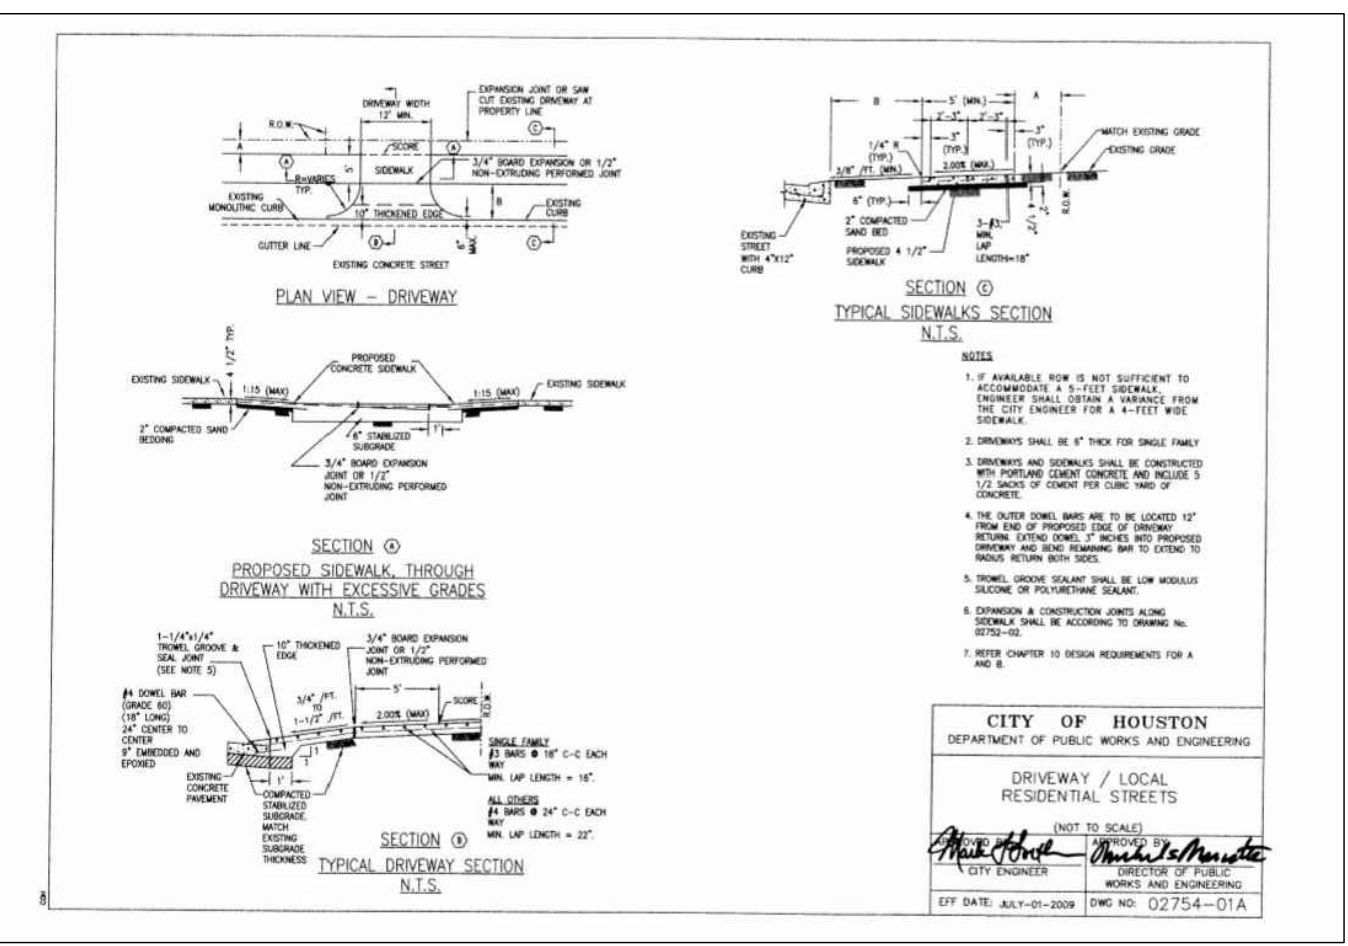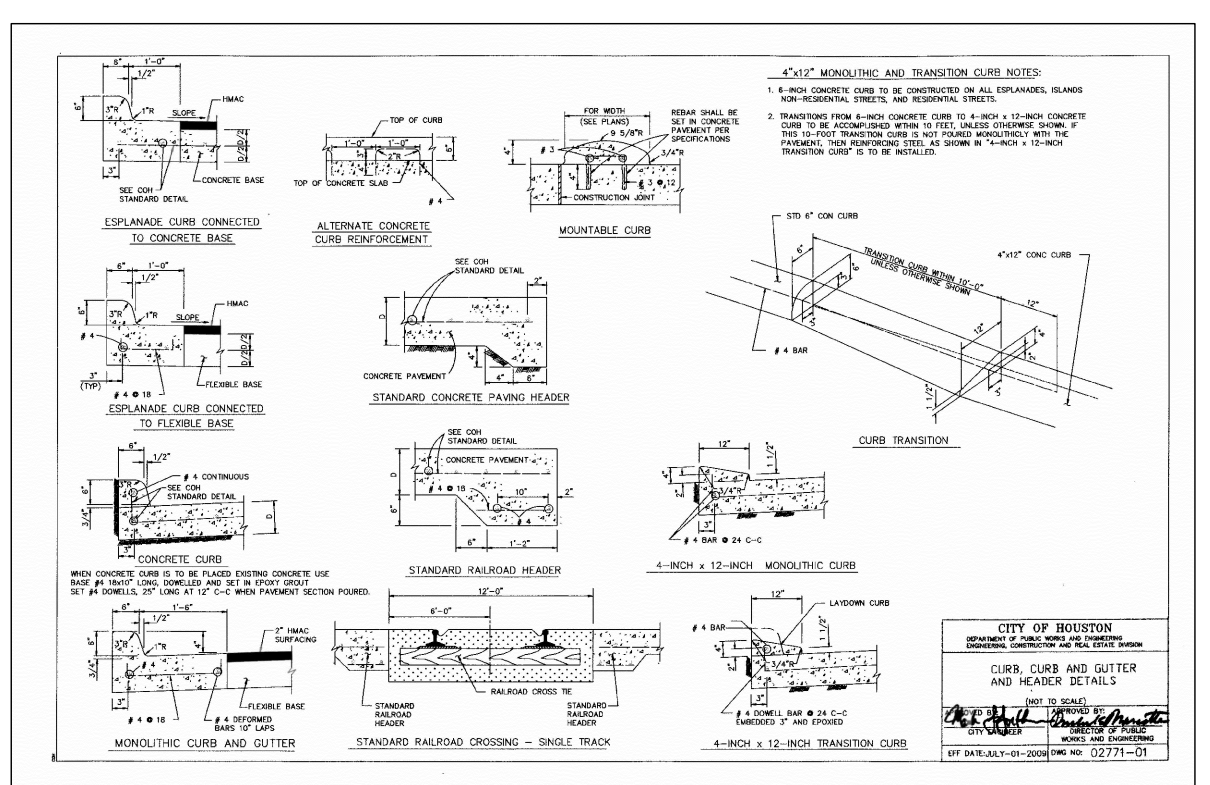

**YALE STREET**  
(80' R.O.W.)  
(60" R.O.W.) VOL 572 PG 523 H.C.D.R.  
(10" R.O.W.) VOL 1279 PG 672 H.C.D.R.

**THORNTON ROAD**  
(40' R.O.W.)  
(VOL. 572, PG 523 H.C.D.R.)

**SITE PLAN**  
Scale: 1/16" = 1'-0"

PLANNING & DEVELOPMENT  
SERVICES DIVISION  
WATER/SEWAGE  
UTILITIES ON SITE  
Nhut Nguyen 4/19/2022



AREA CALCULATIONS		DOOR SCHEDULE				
		DOOR NO.	QTY.	WIDTH	HEIGHT	DESCRIPTION
FIRST FLOOR:	299 SQ. FT.	①	1	3'-0"	8'-0"	EXTERIOR FRONT DOOR
SECOND FLOOR:	713 SQ. FT.	②	1	2'-8"	6'-8"	20 MIN. FIRE RATED/SELF CLOSING DOOR AT GARAGE
THIRD FLOOR:	789 SQ. FT.	③	6	2'-4"	6'-8"	INTERIOR DOOR
TOTAL LIVING:	1,801 SQ. FT.	④	1	2'-4"	8'-0"	INTERIOR DOOR
GARAGE	371 SQ. FT.	⑤	1	2'-8"	6'-8"	EXTERIOR DOOR
BALCONY	76 SQ. FT.	⑥	1	2'-2"-6"	6'-8"	DOUBLE INTERIOR DOOR
CARPOT	105 SQ. FT.	⑦	3	2'-8"	6'-8"	INTERIOR DOOR
PORCH	14 SQ. FT.	⑧	1	3'-0"	8'-0"	EXTERIOR DOOR
TOTAL COVERED AREA	2,367 SQ. FT.	⑨	2	2'-0"	6'-8"	INTERIOR DOOR
		⑩	1	16'-0"	7'-0"	OVERHEAD GARAGE DOOR


WINDOW SCHEDULE				
MARK	QTY	WIDTH	HEIGHT	DESCRIPTION
A	1	2'-3'-0"	5'-0"	SINGLE HUNG WINDOW
B	3	3'-0"	6'-0"	SINGLE HUNG WINDOW
C	1	3'-0"	5'-0"	SINGLE HUNG WINDOW
D	2	2'-0"	6'-0"	SINGLE HUNG WINDOW
E	2	4'-0"	4'-0"	SINGLE HUNG WINDOW

xRECESS SUB-FLOOR FOR ALL TILED AREAS


NOTE:

1. VERIFY WITH WINDOW MANUFACTURER FOR TRUE  
ROUGH OPENING SIZES.
2. DOORS AND WINDOWS SELECTION BY BUILDER/OWNER.
3. ALL WALL DIMENSIONS ARE TO FACE OF FRAMING.
4. ALL DIMENSIONS TO DOORS AND WINDOWS ARE TO THE CENTER OF OPENING.
5. 2X6 FRAMING AT PLUMBING WALLS.
6. DBL 2X4 OR 2X6 WALLS REQUIRED FOR CEILING HEIGHTS OVER 10'-0".
7. ALL WALLS WITH 5/8 TYPE X SHEETROCK
8. RETURN AIR PROPERLY SEALED. LOCAL AMENDMENT REQUIRES THAT R/A FILTERS BE  
WITHIN 24 INCHES OF THE FLOOR OR HAVE INSTALLED AT THE EQUIPMENT A MEDIA-TYPE  
OR ELECTROSTATIC-TYPE AIR FILTER

- ALL GLAZING SHALL HAVE A .4 U-FACTOR & .25 SHGC OR BETTER.

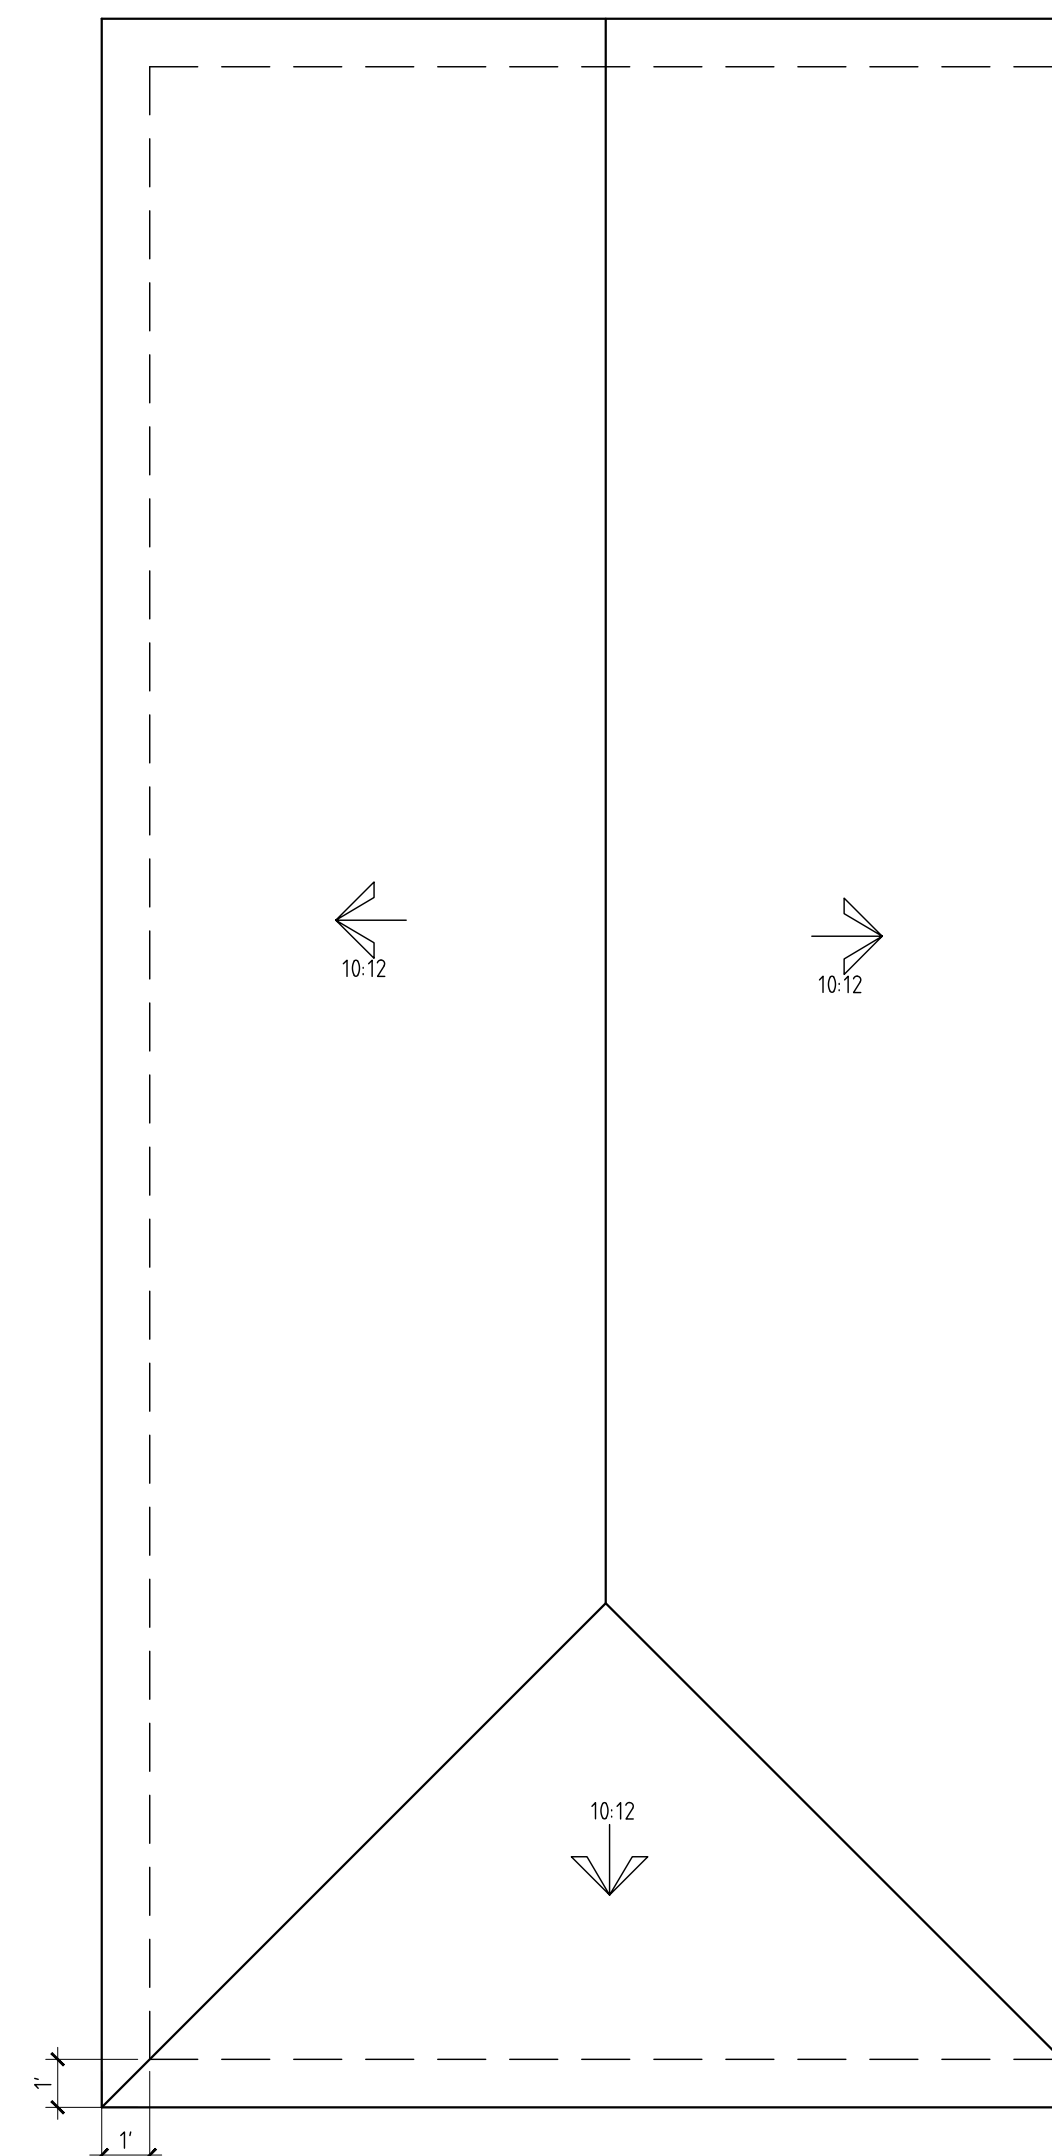


ROOF PLAN  
Scale: 1/4"= 1'-0"

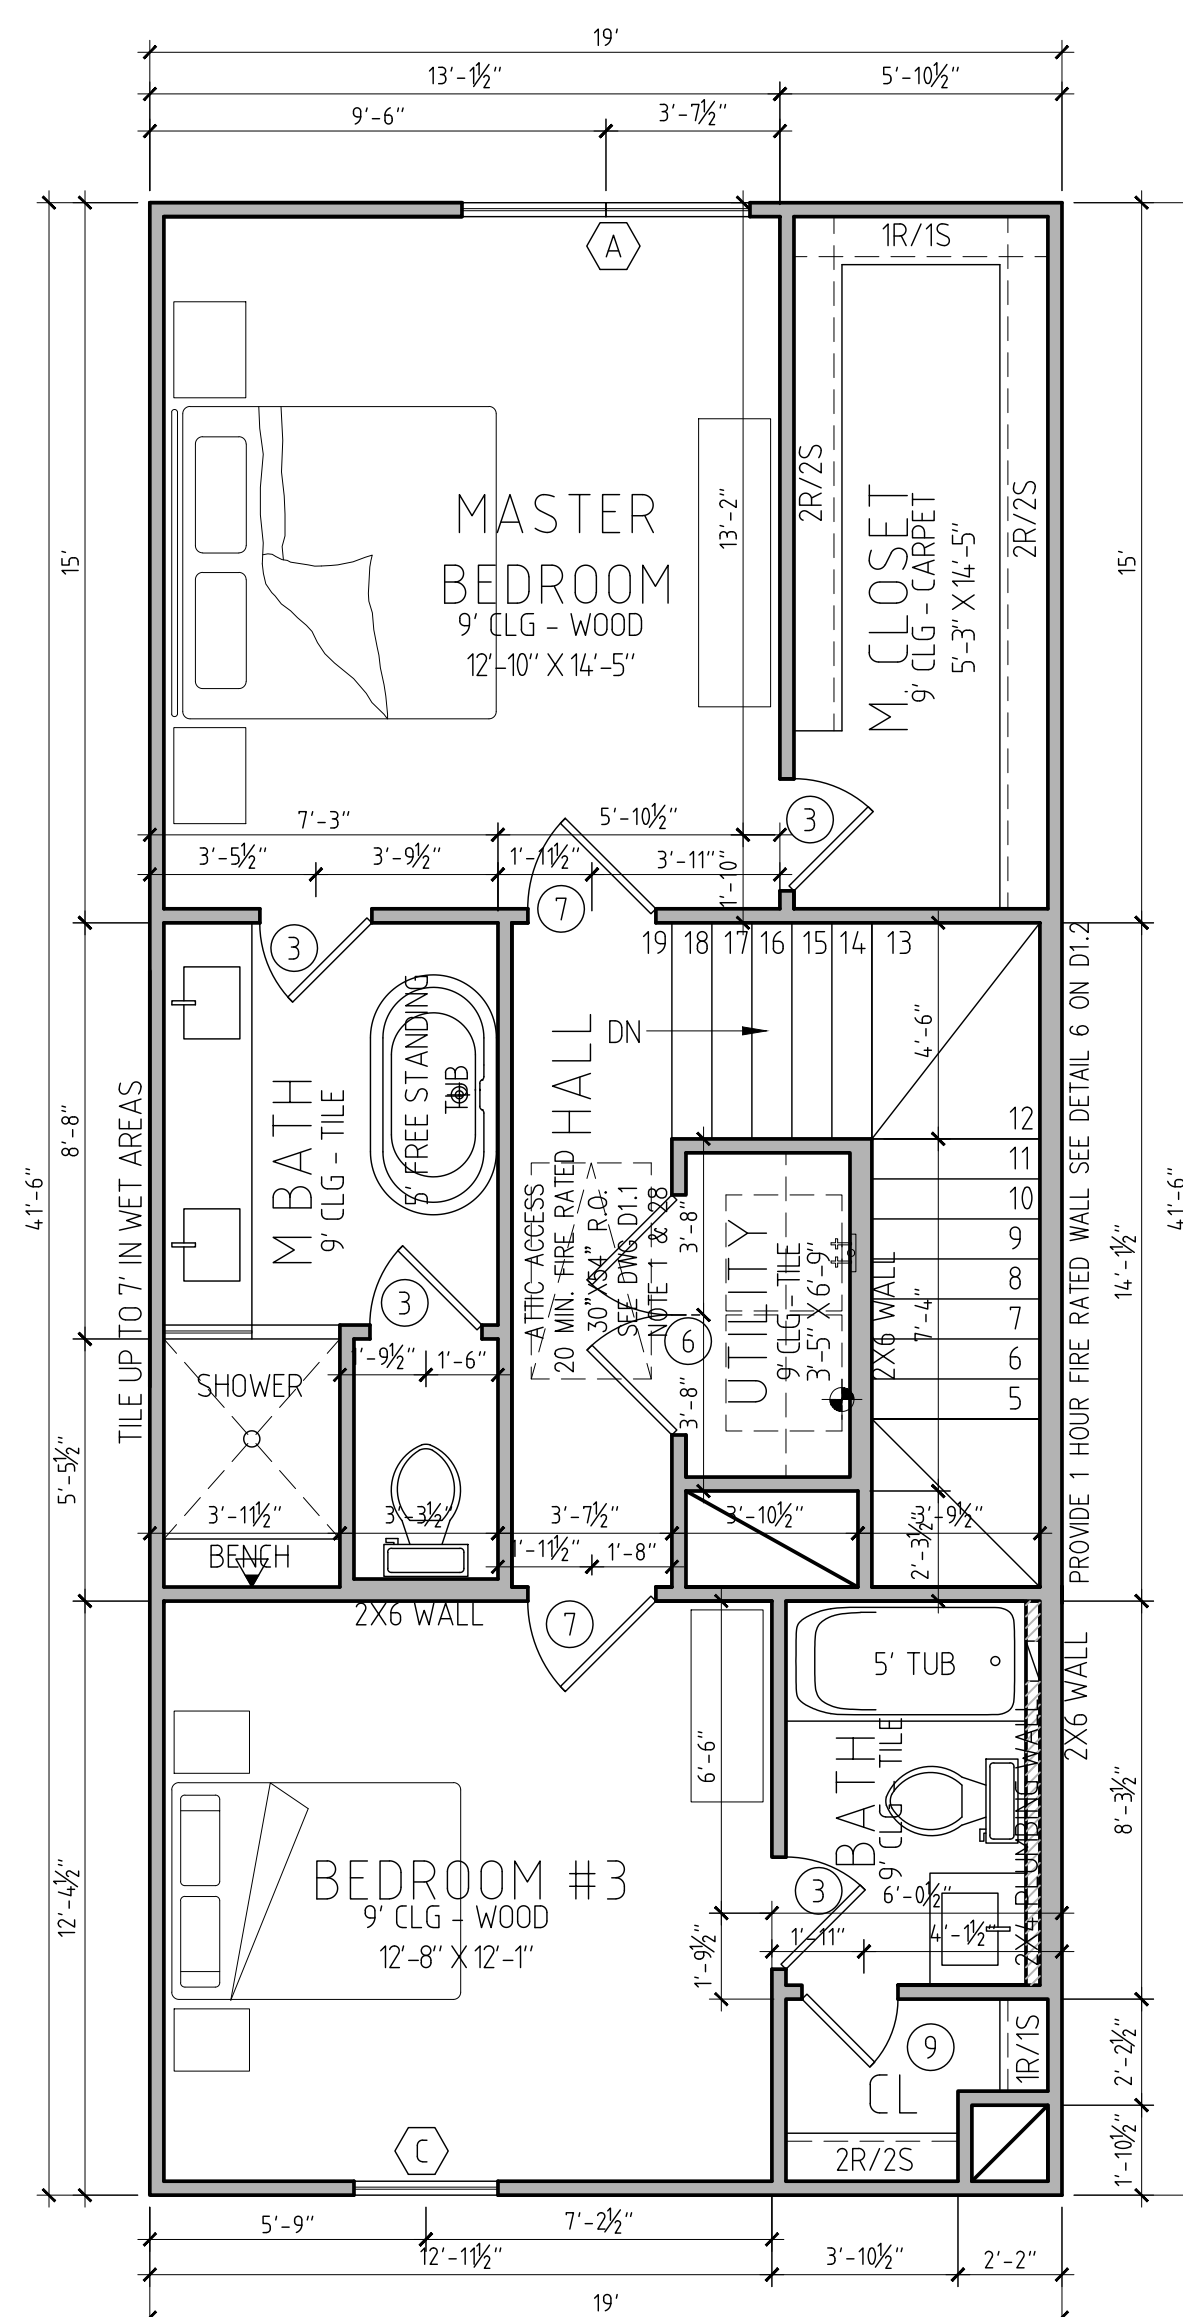


### THIRD FLOOR PLAN

Scale: 1/4"= 1'-0"

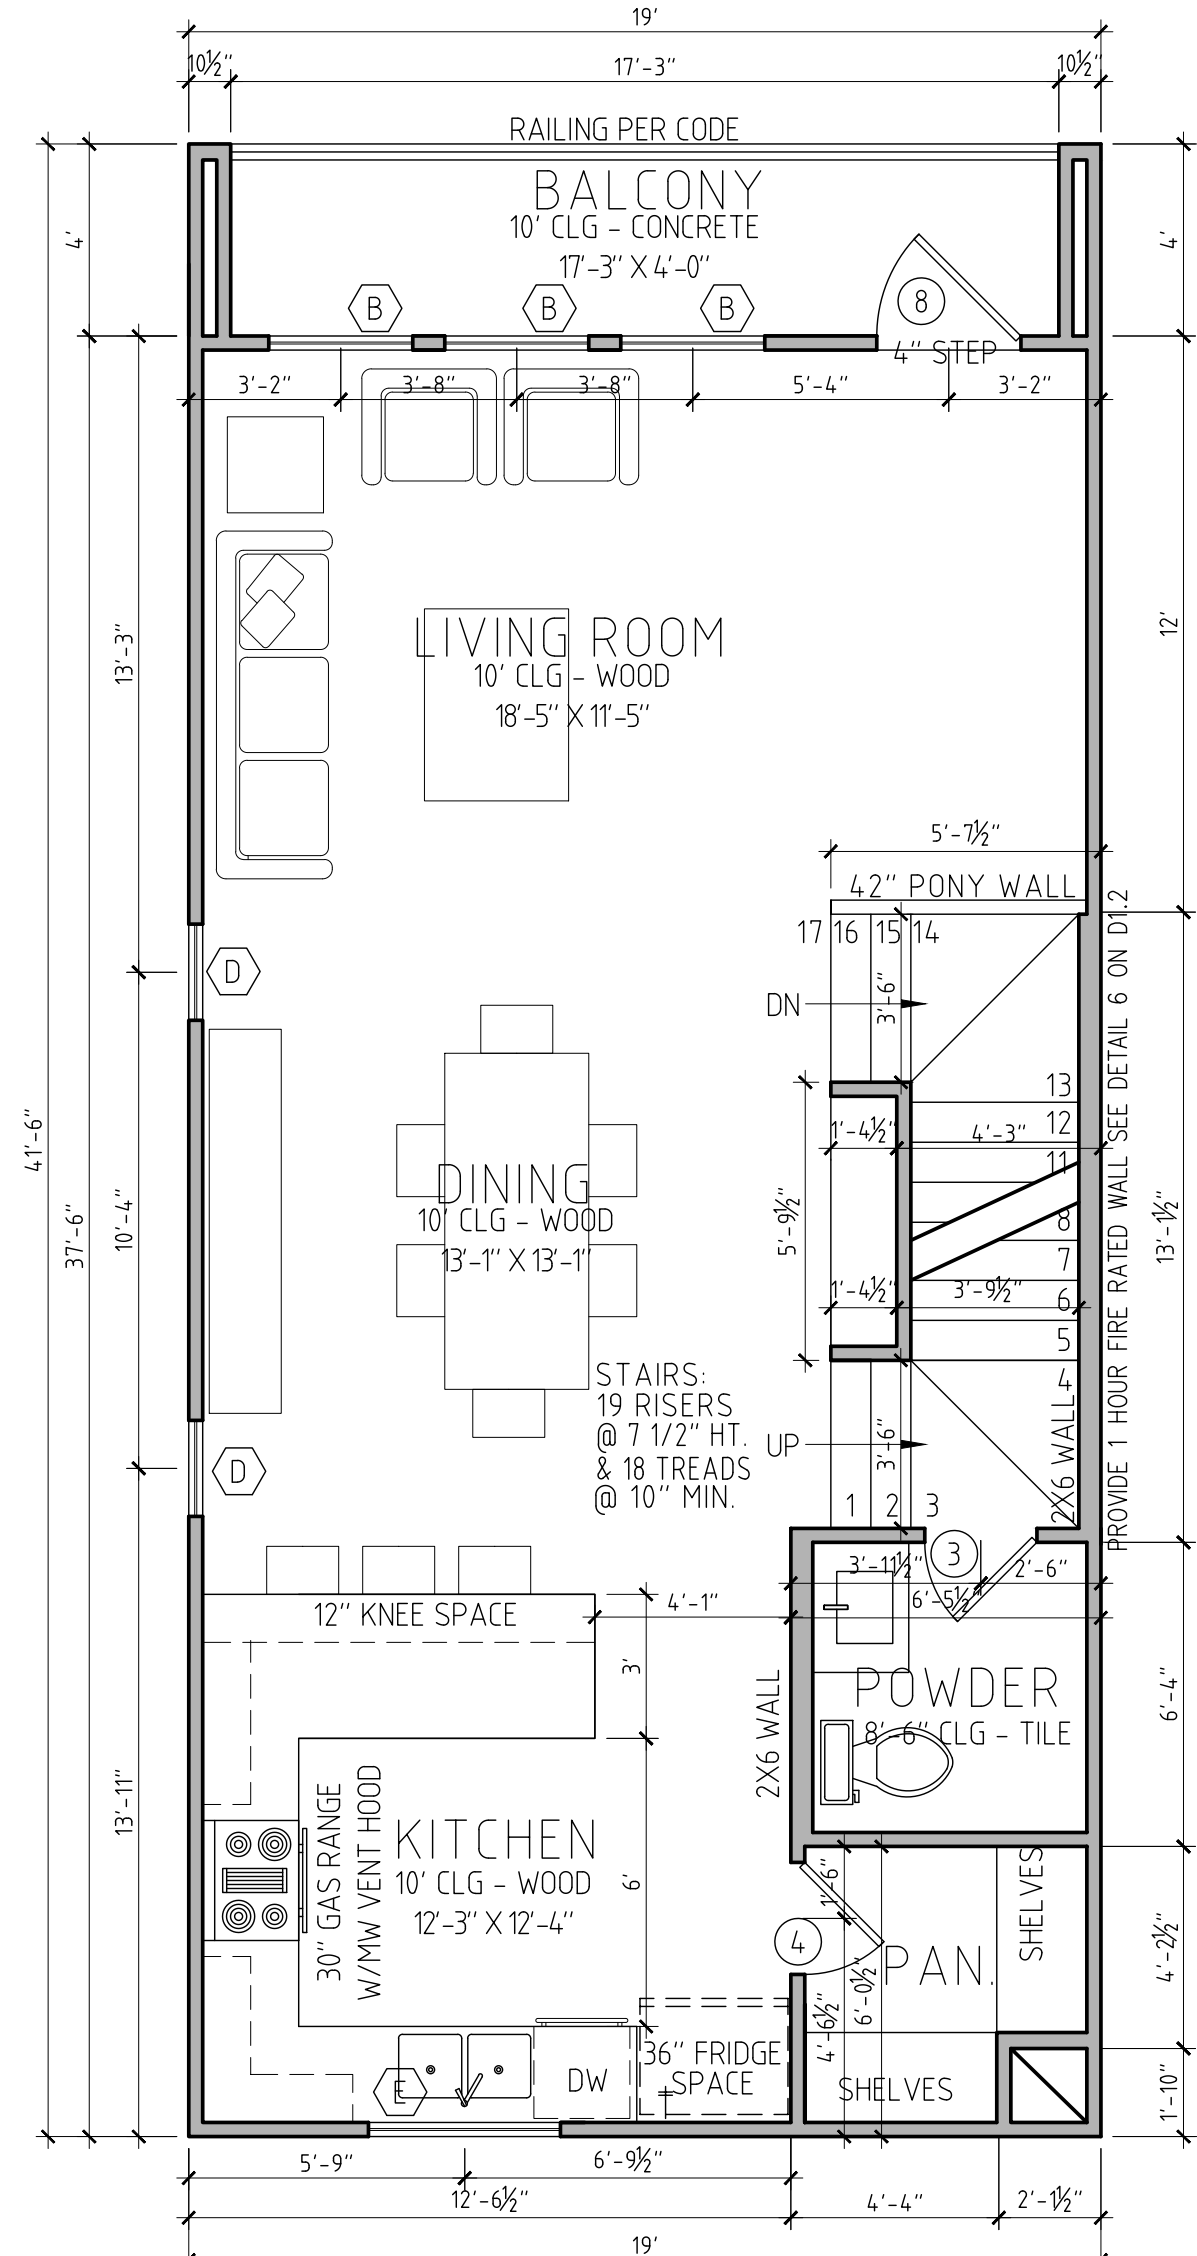

## SECOND FLOOR PLAN

Scale: 1/4" = 1'-0"

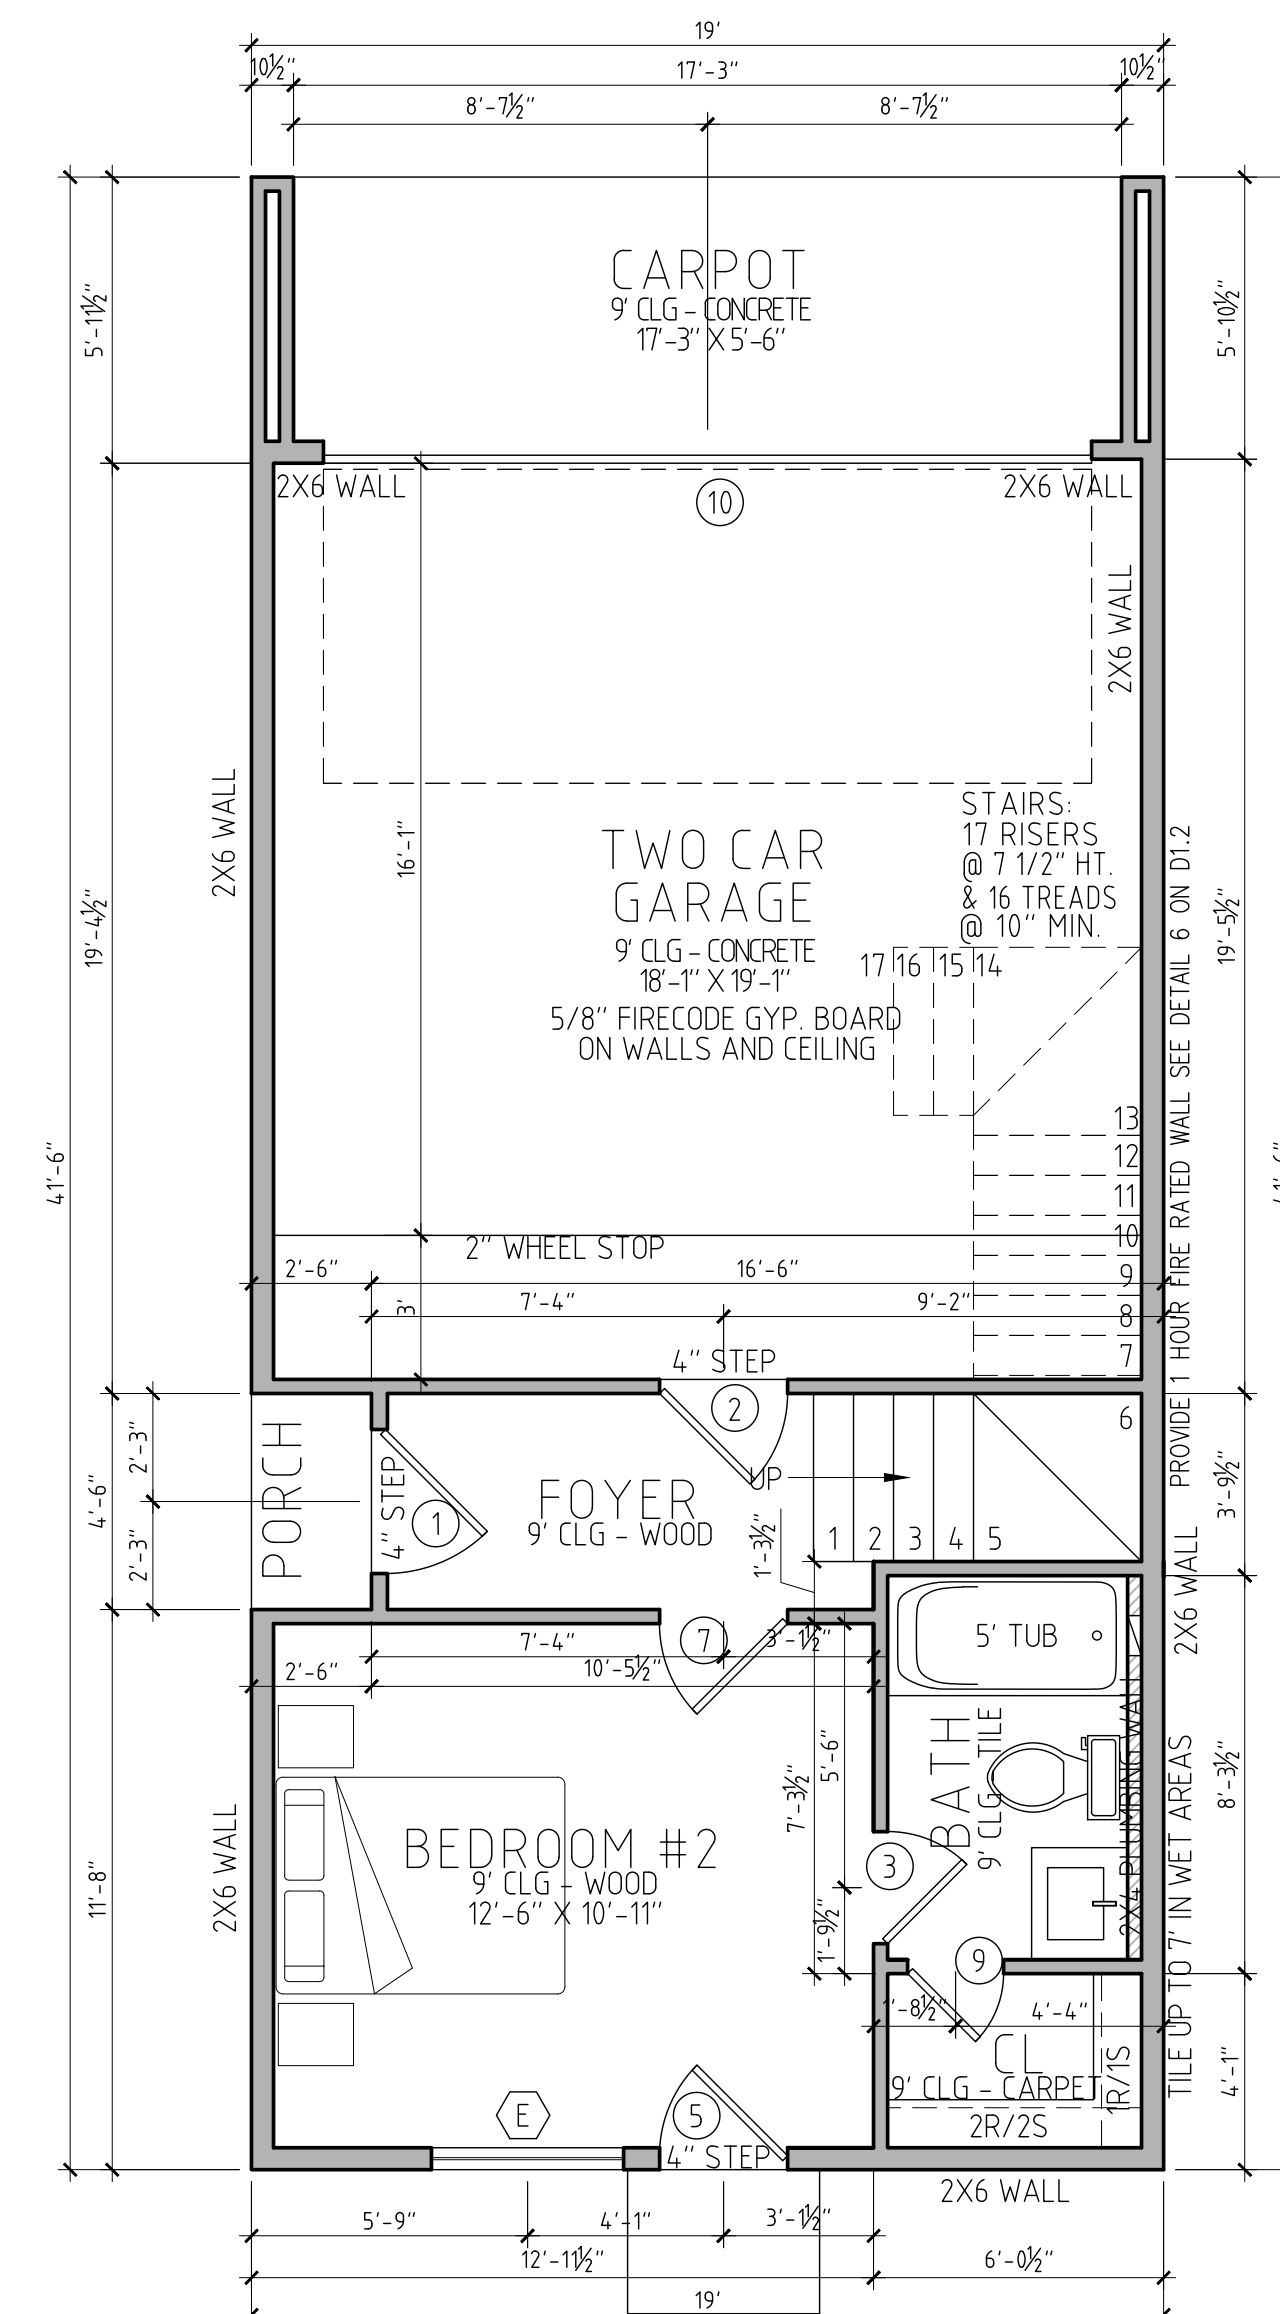

FIRST FLOOR PLAN  
Scale: 1/4"= 1'-0"

MARK	DATE	DESCRIPTION	MARK	DATE	DESCRIPTION
A.	11/24/21	ISSUED FOR COH			
					CAD DWG FILE: TEXT
					COPYRIGHT 2008 ALL RIGHTS RESERVED DRAWN BY: FD

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316 A, 316 I, 316 J, 316 K, 316 L, 316 M &  
316 N THORNTON ROAD  
4605 B, 4605 C, 4605 D, 4605 E, 4605 F &  
4605 L YALE STREET  
HOUSTON, TEXAS.

SHEET TITLE


## FLOOR PLANS

SHEET NO.

## A1.1





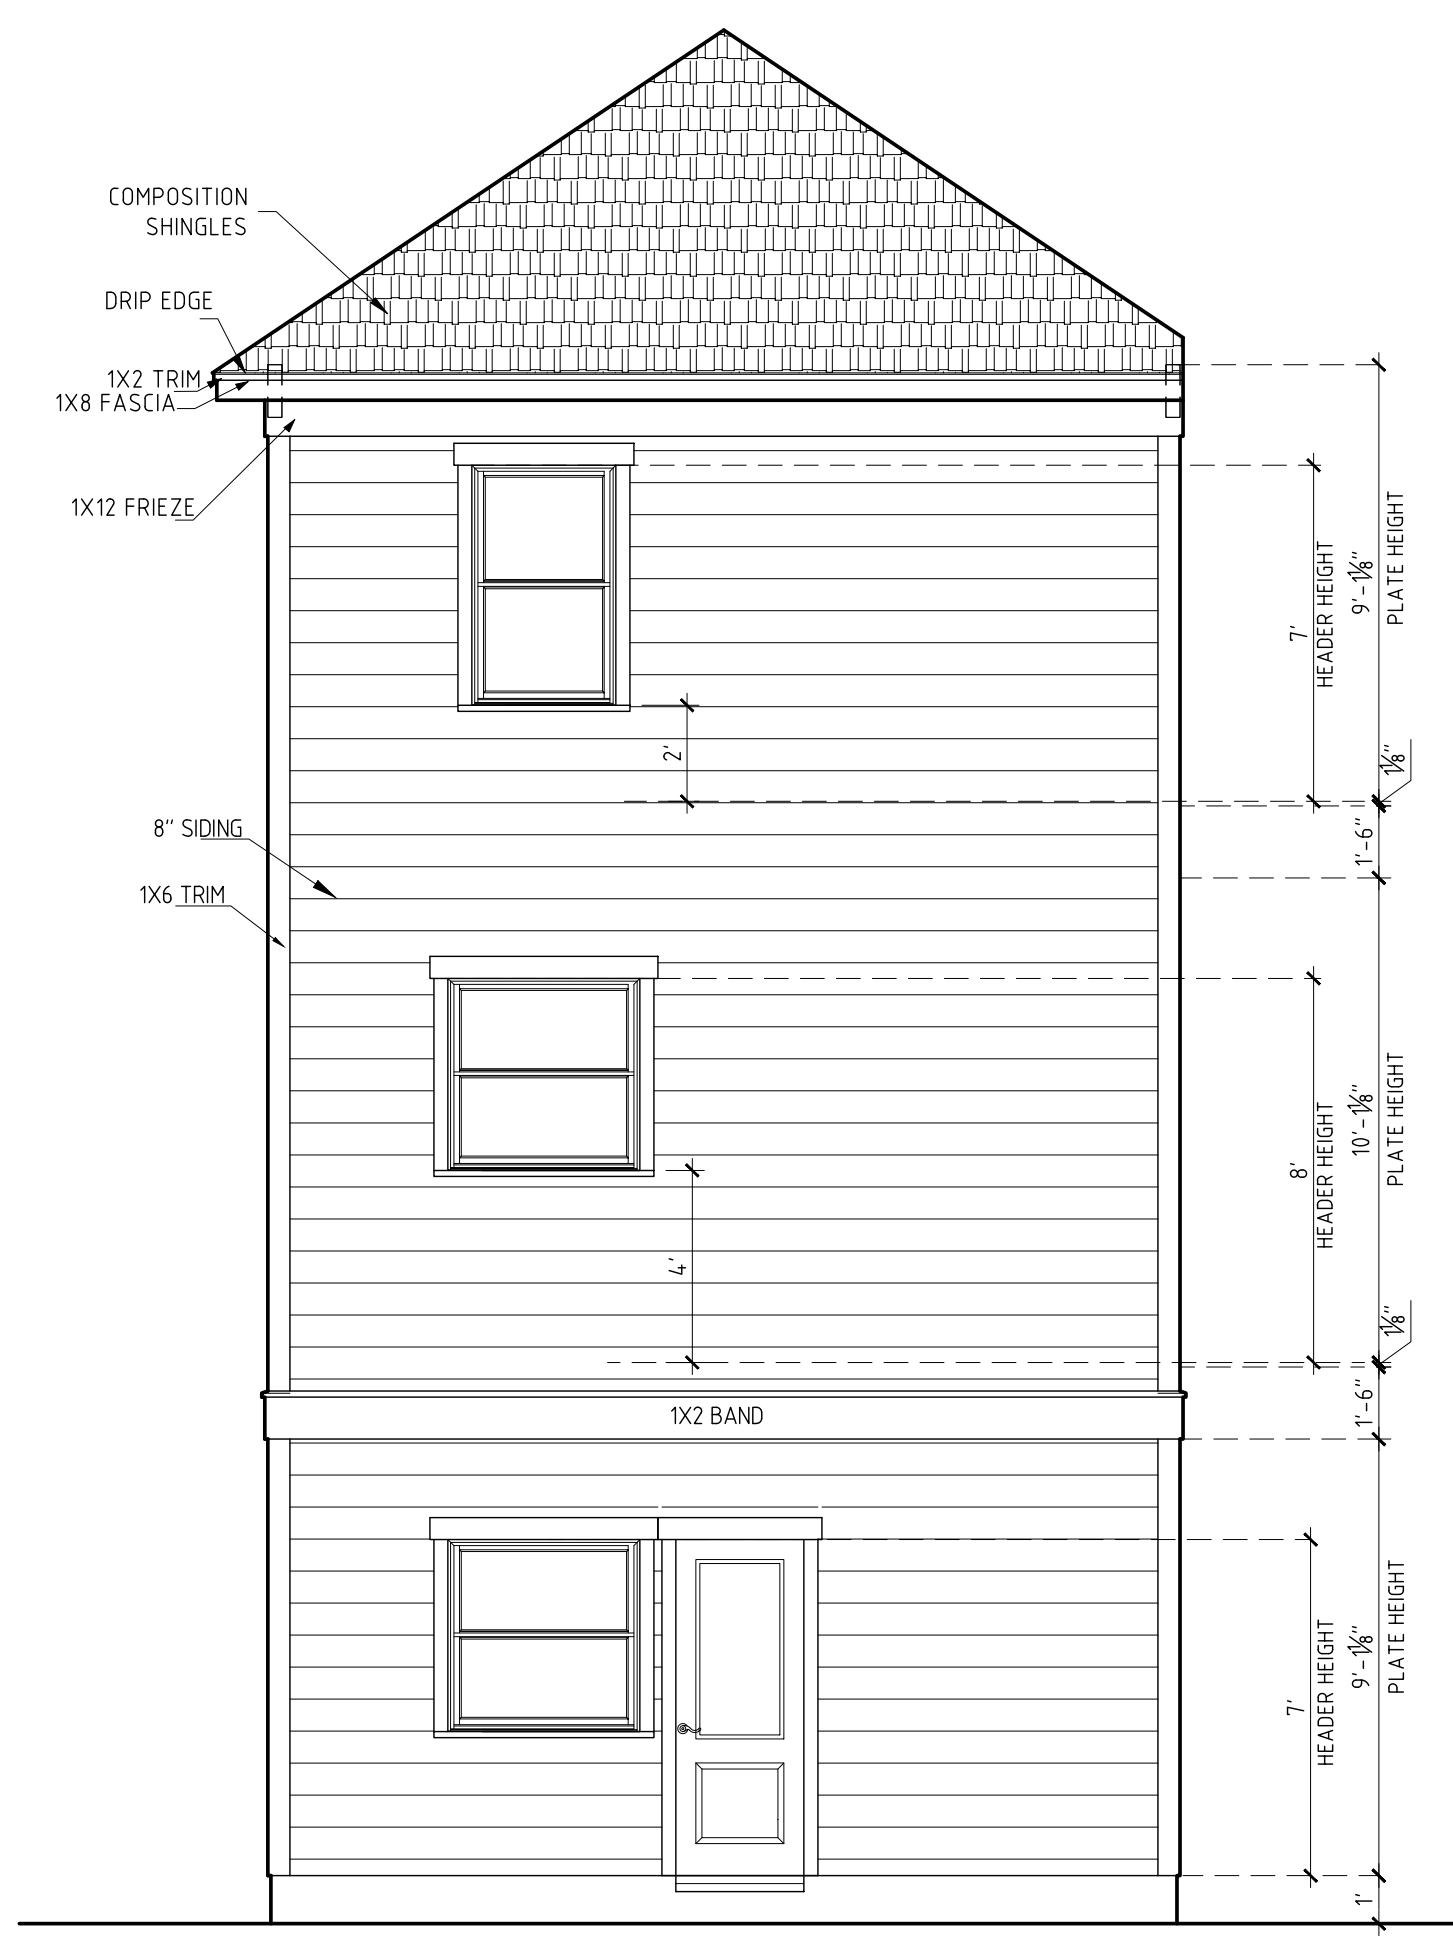


REAR ELEVATION  
Scale: 1/4"= 1'-0"




**RIGHT SIDE ELEVATION**

Scale: 1/4"= 1'-0"

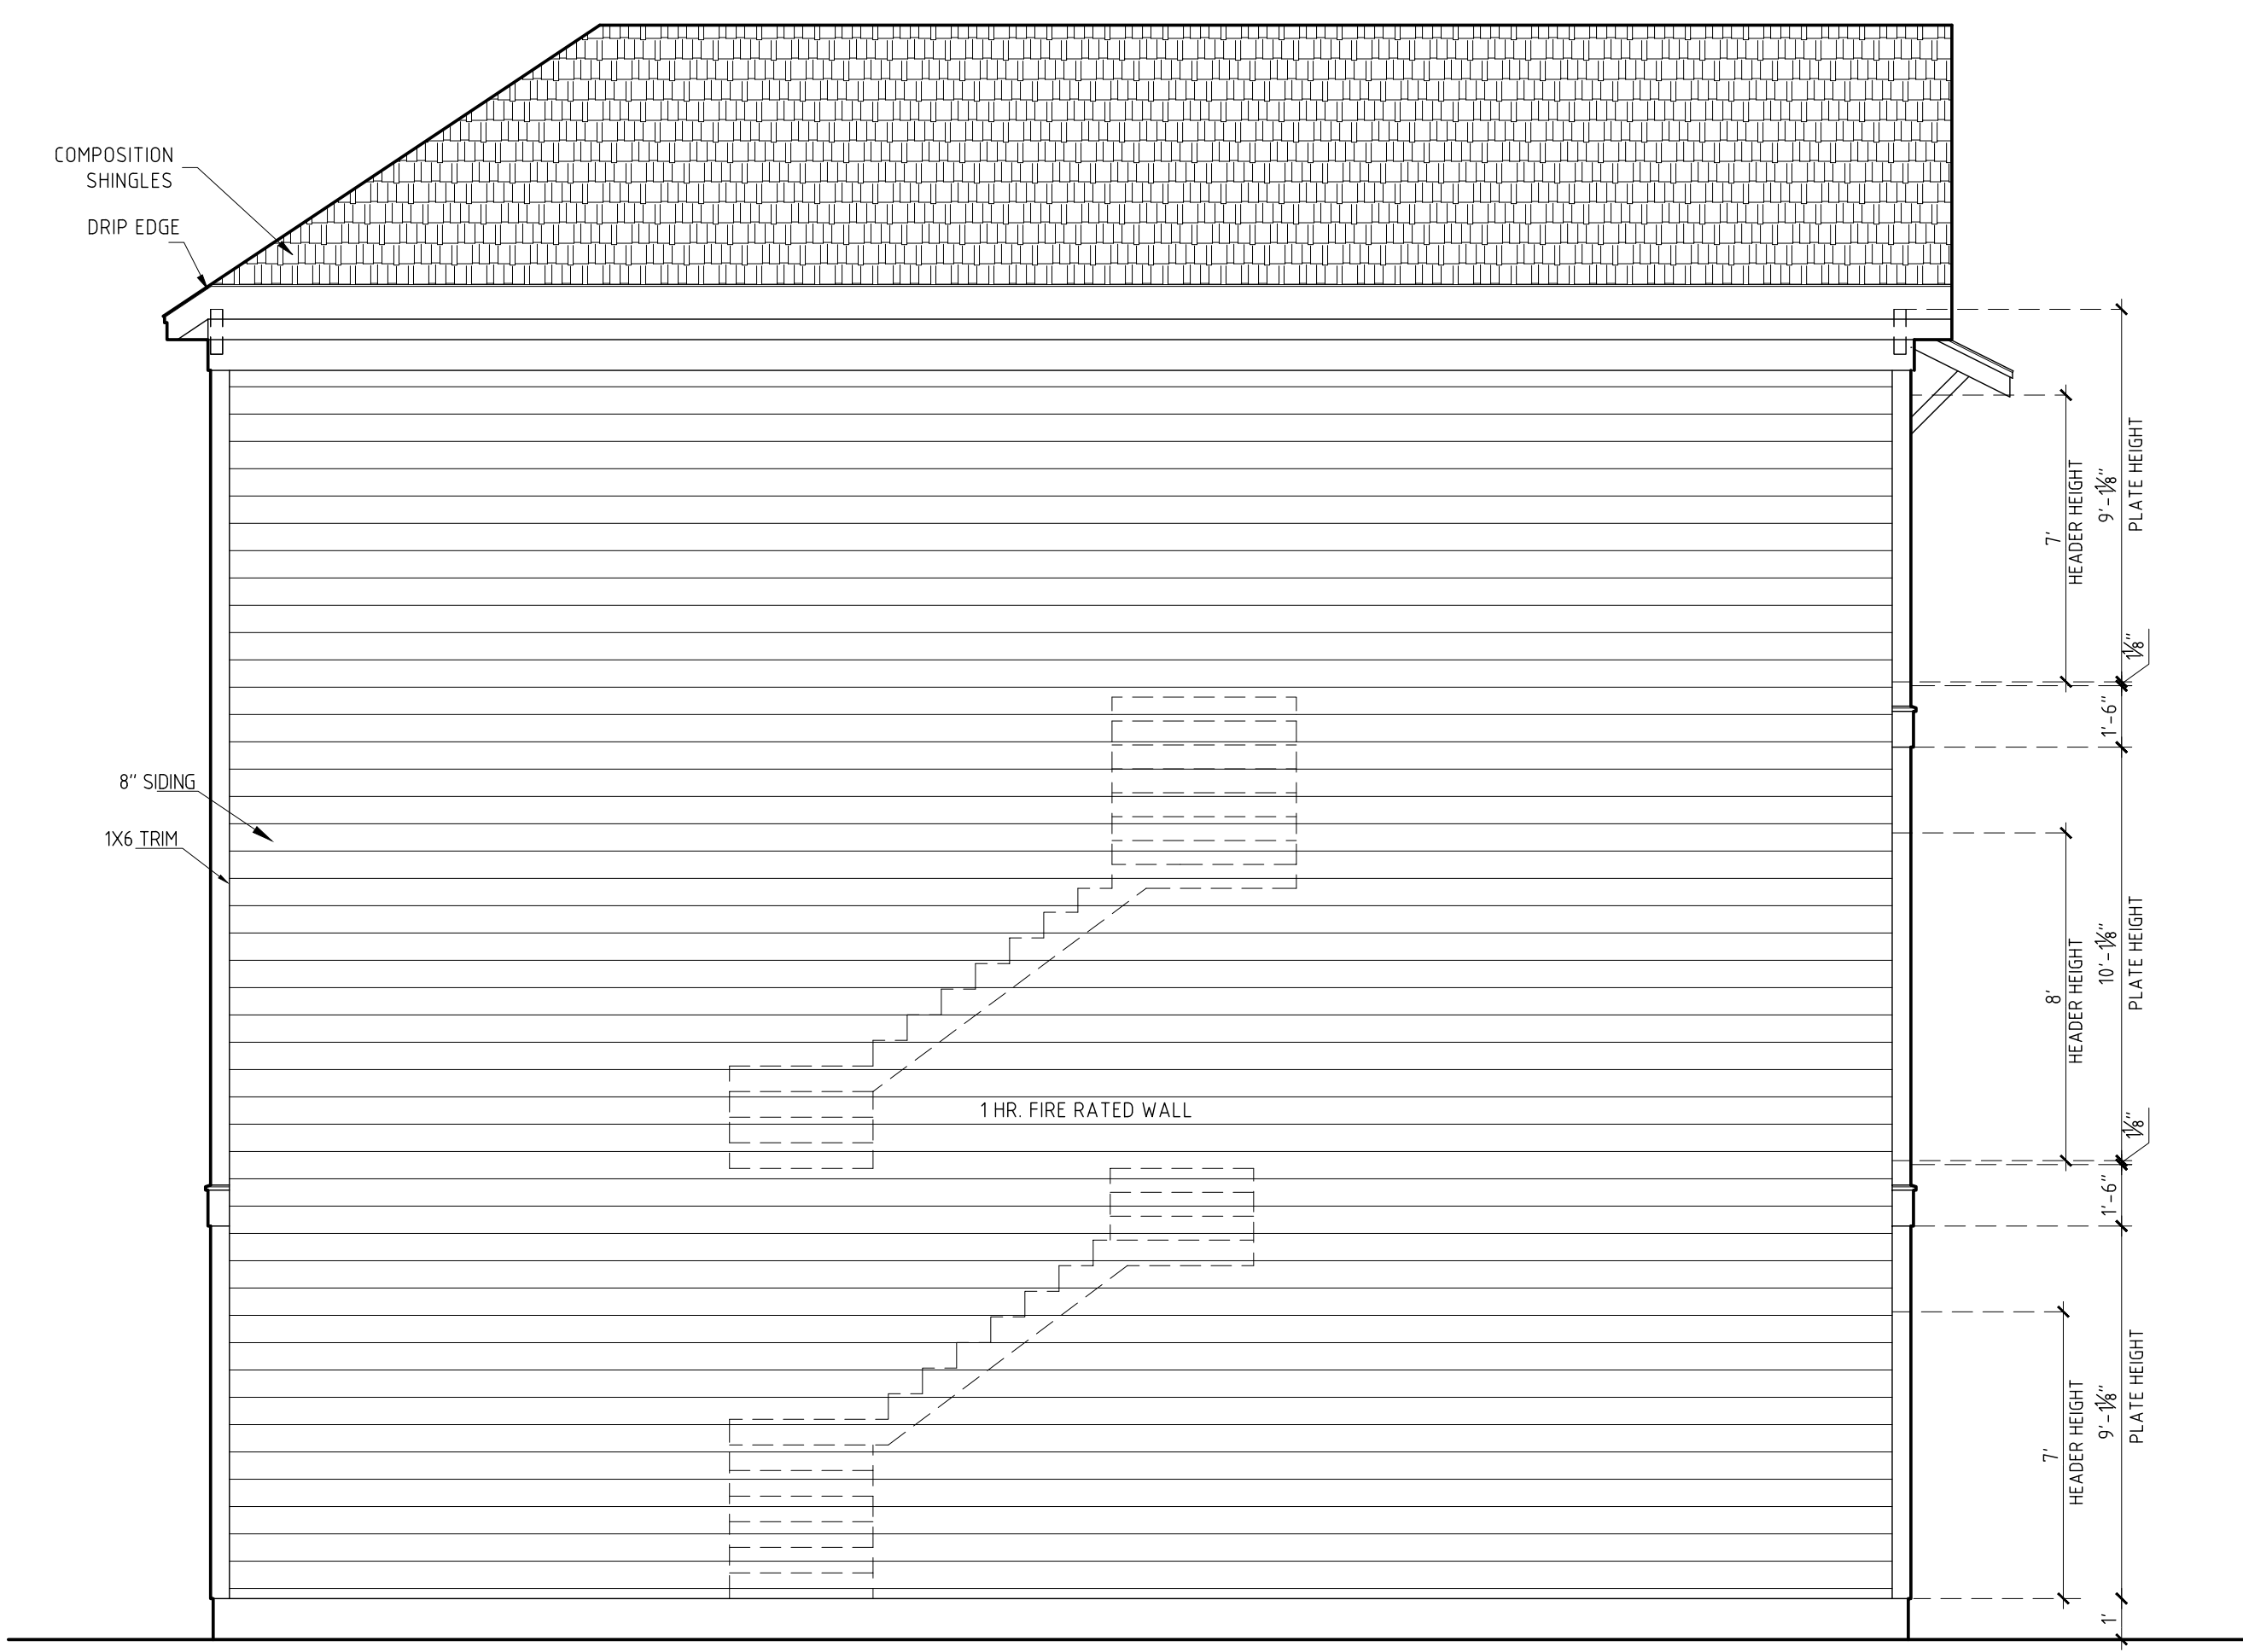

LEFT SIDE ELEVATION  
Scale: 1/4"= 1'-0"

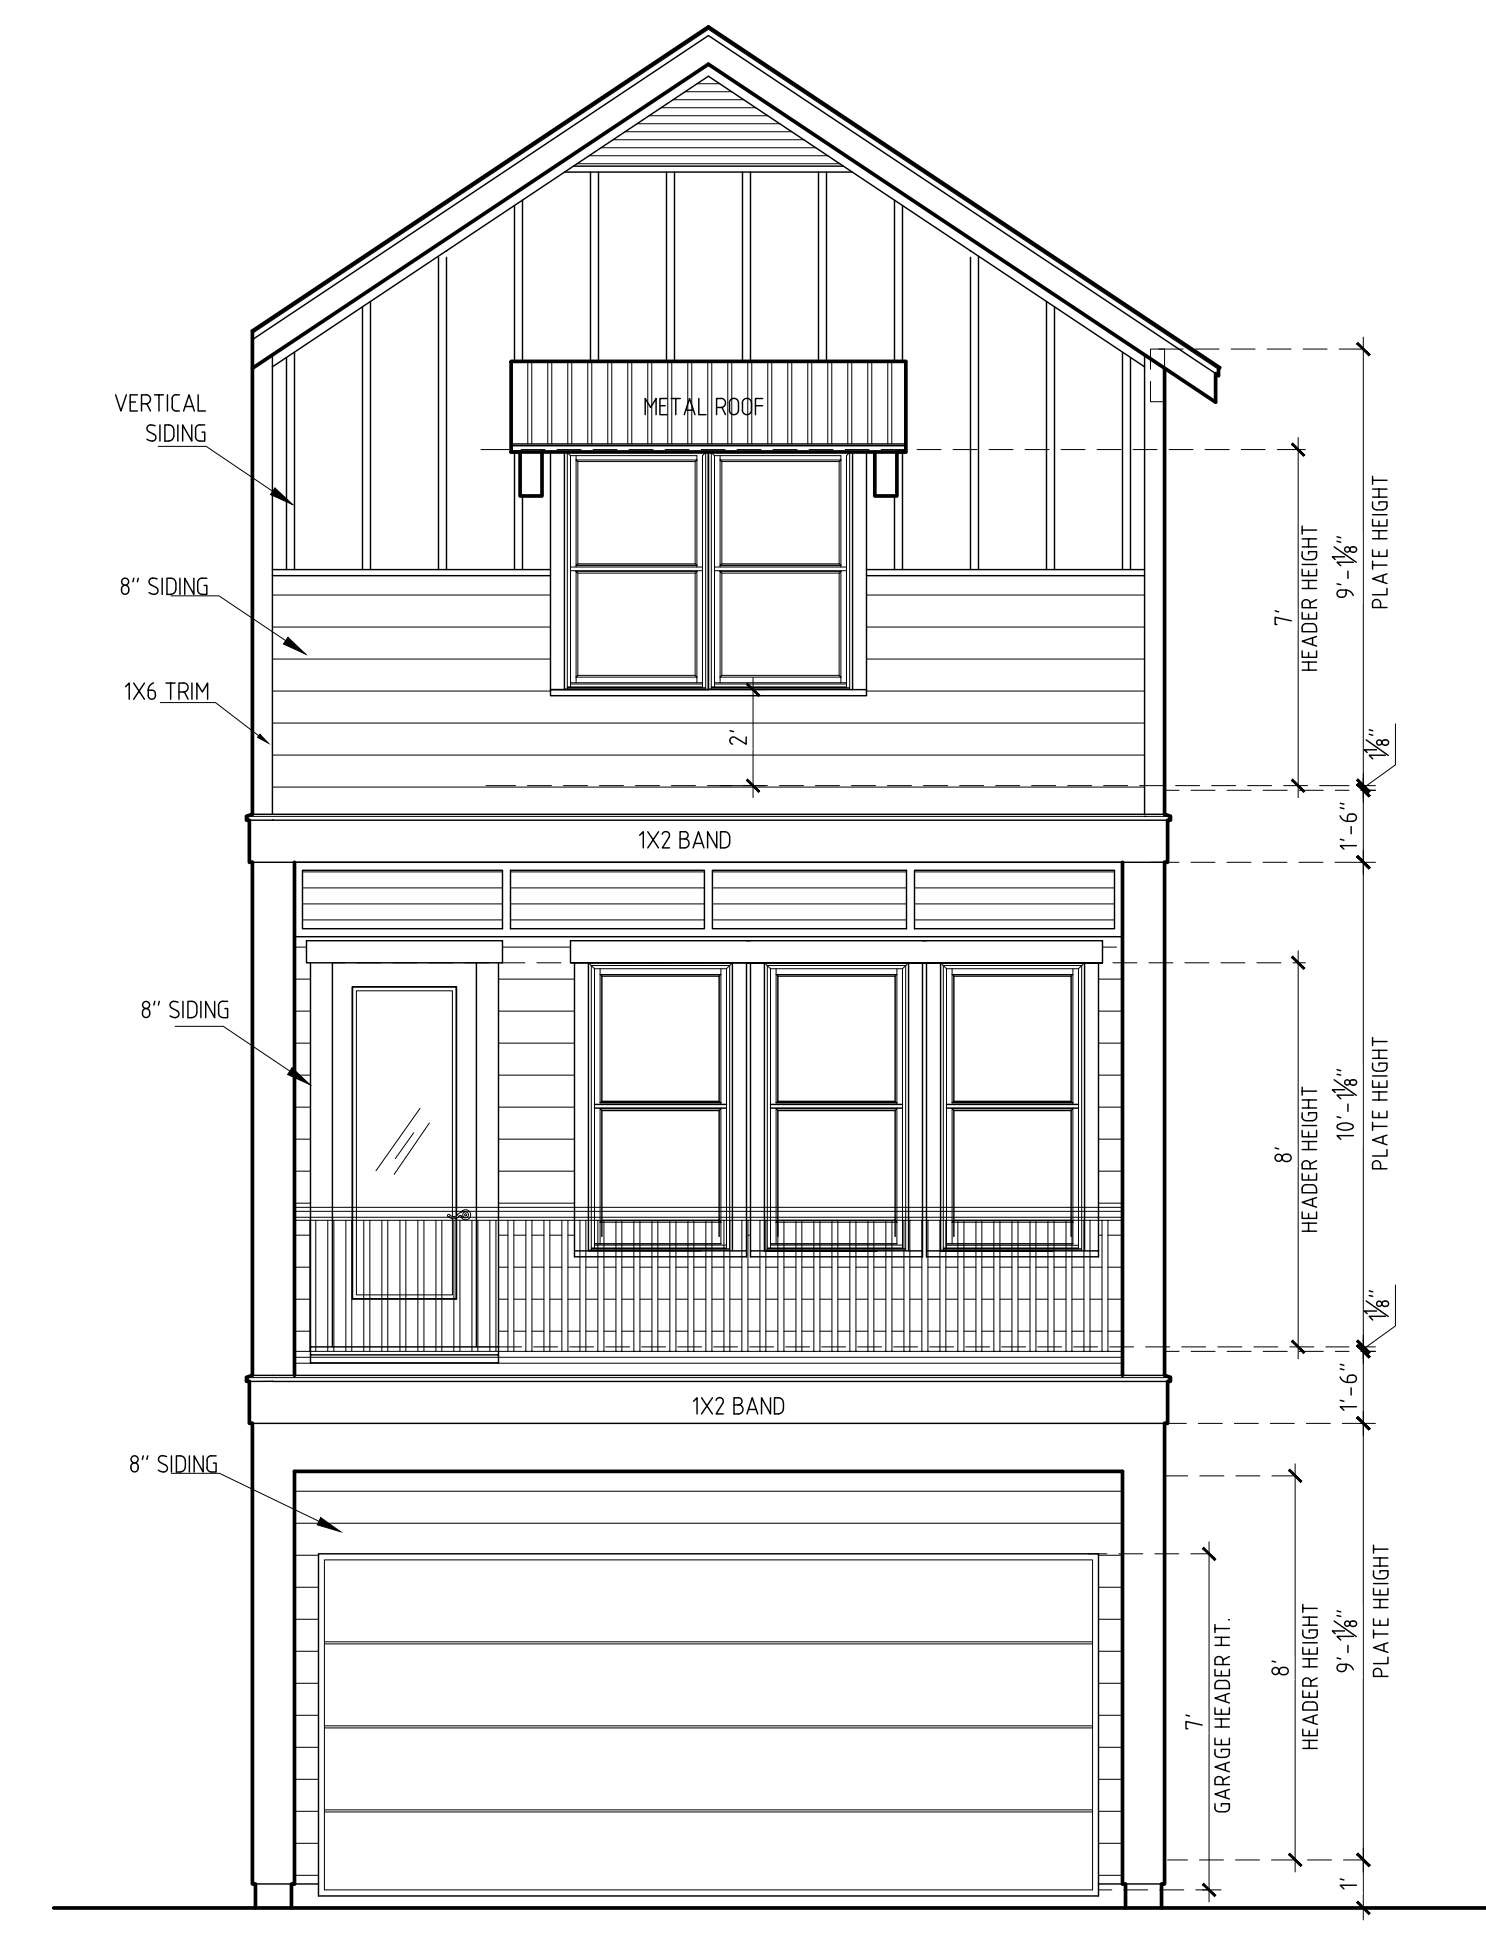

**FRONT ELEVATION**

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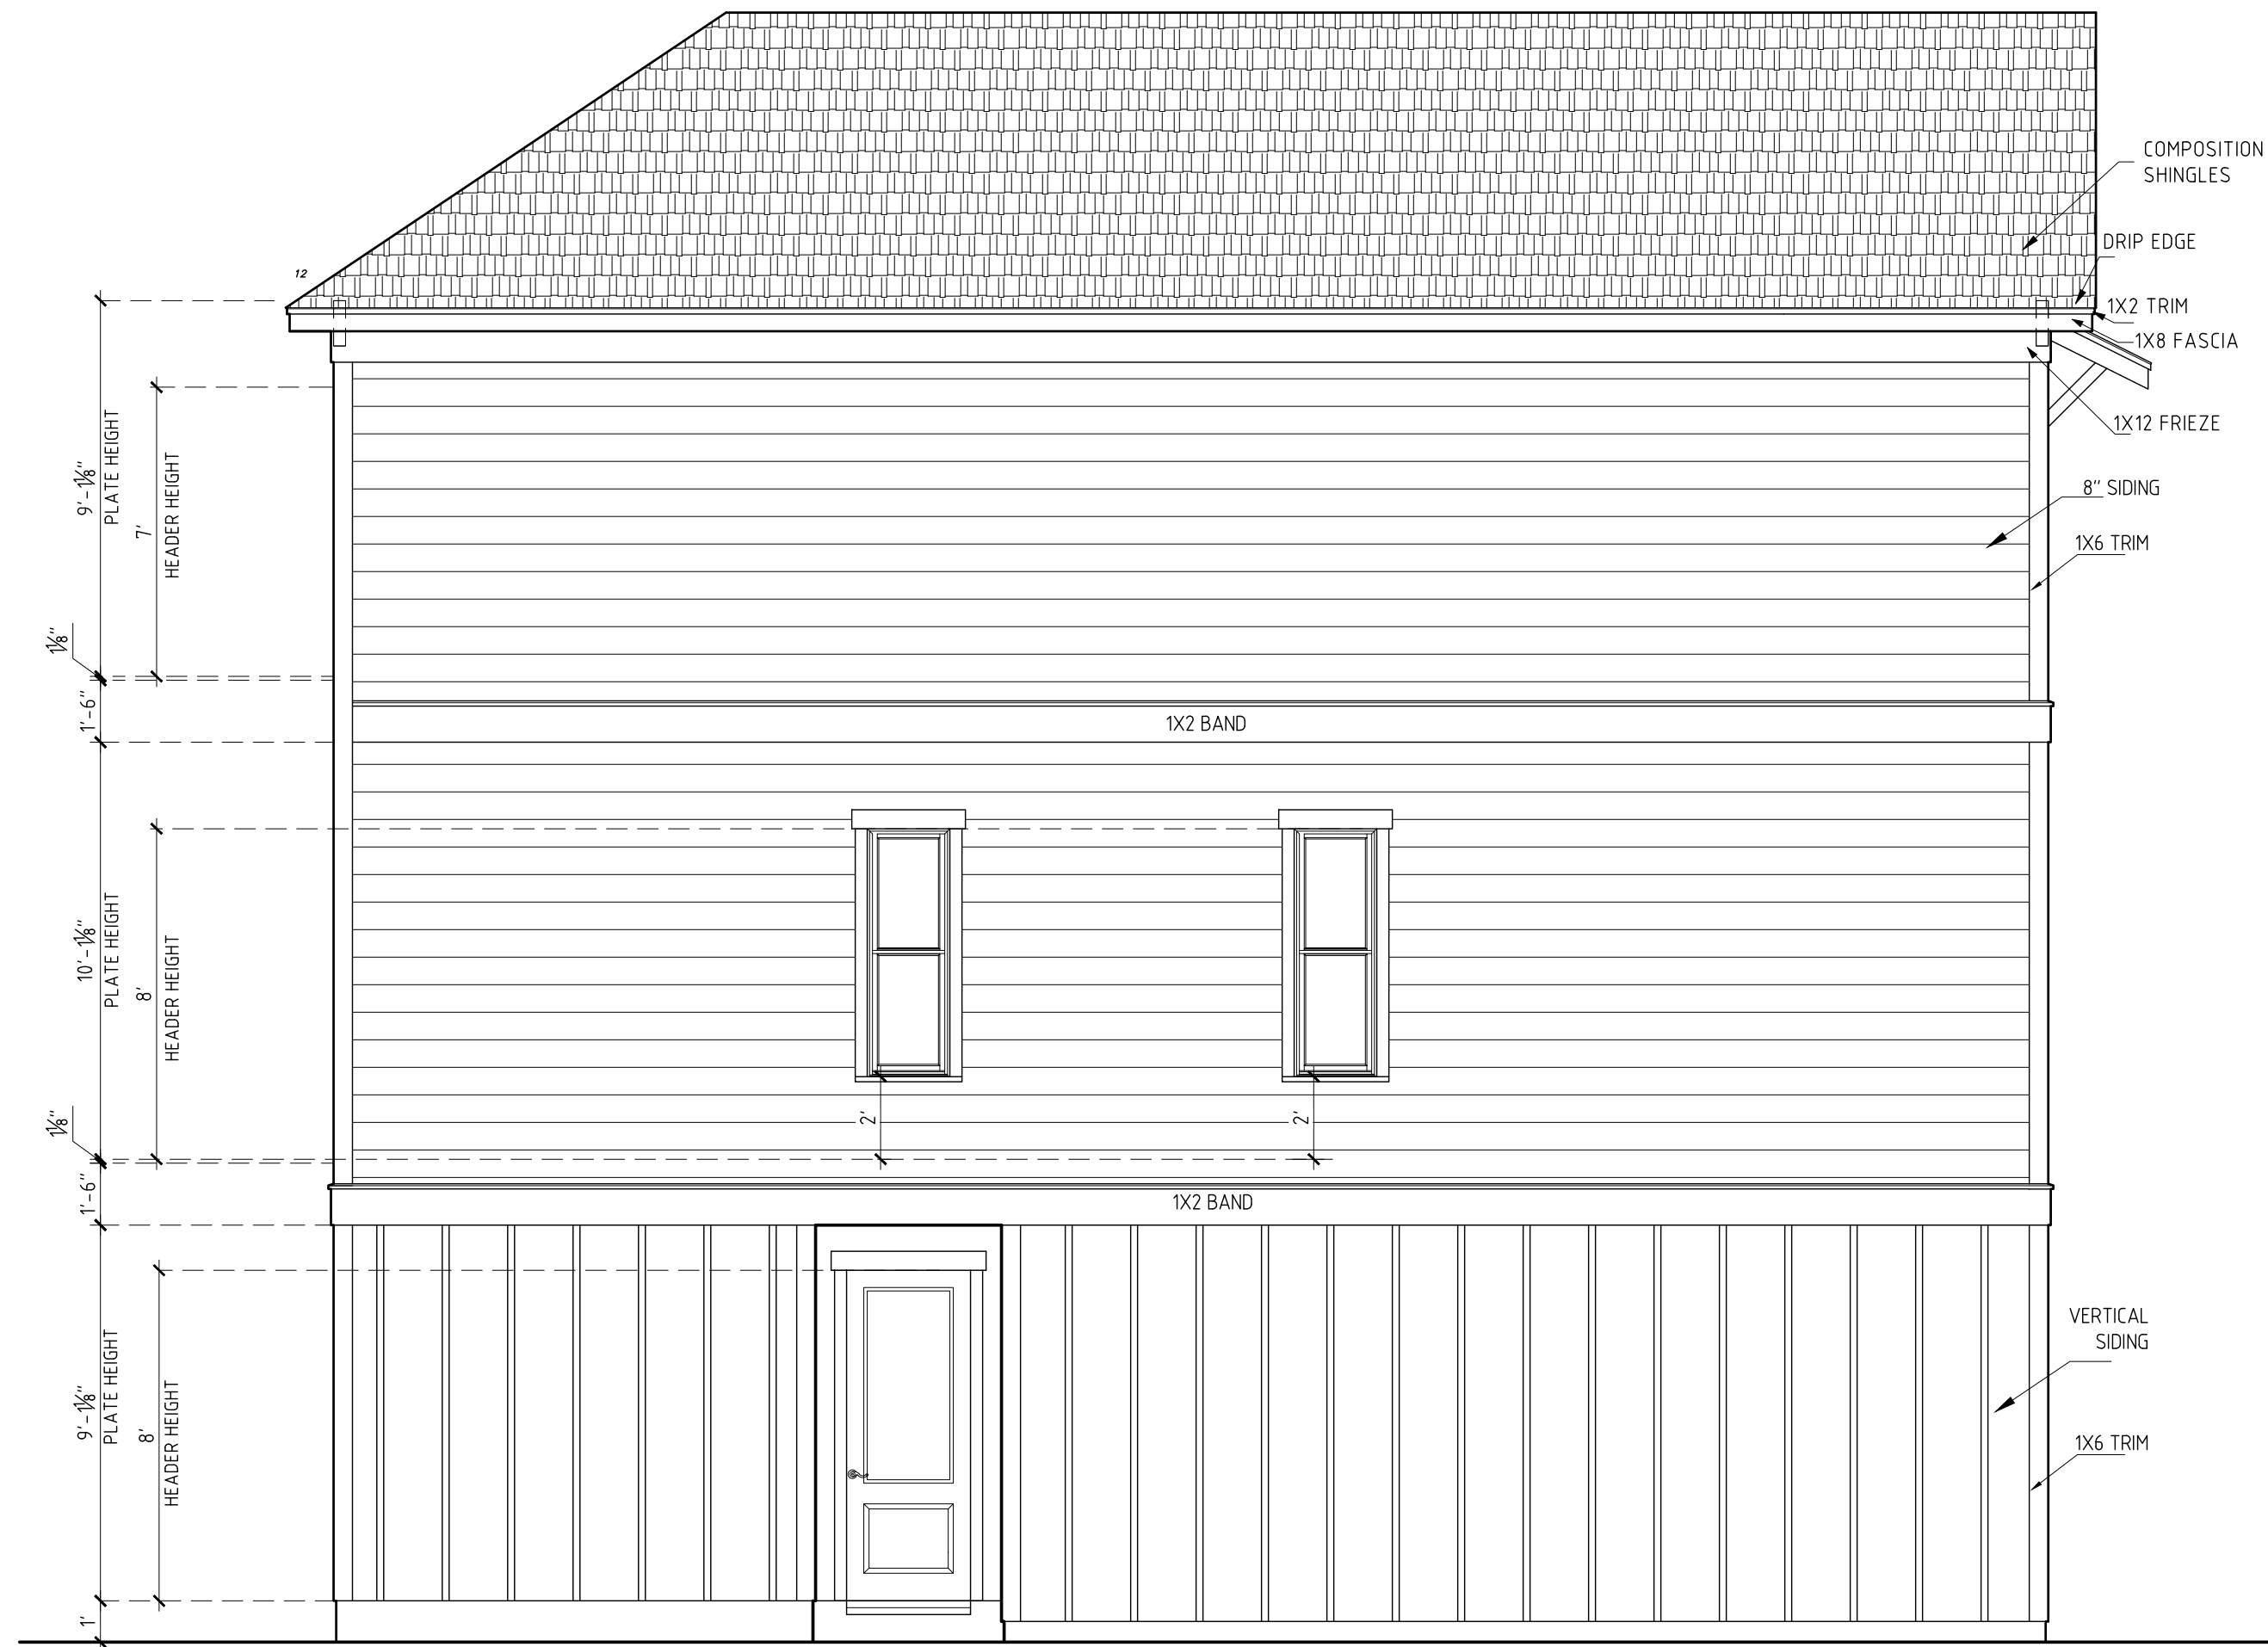
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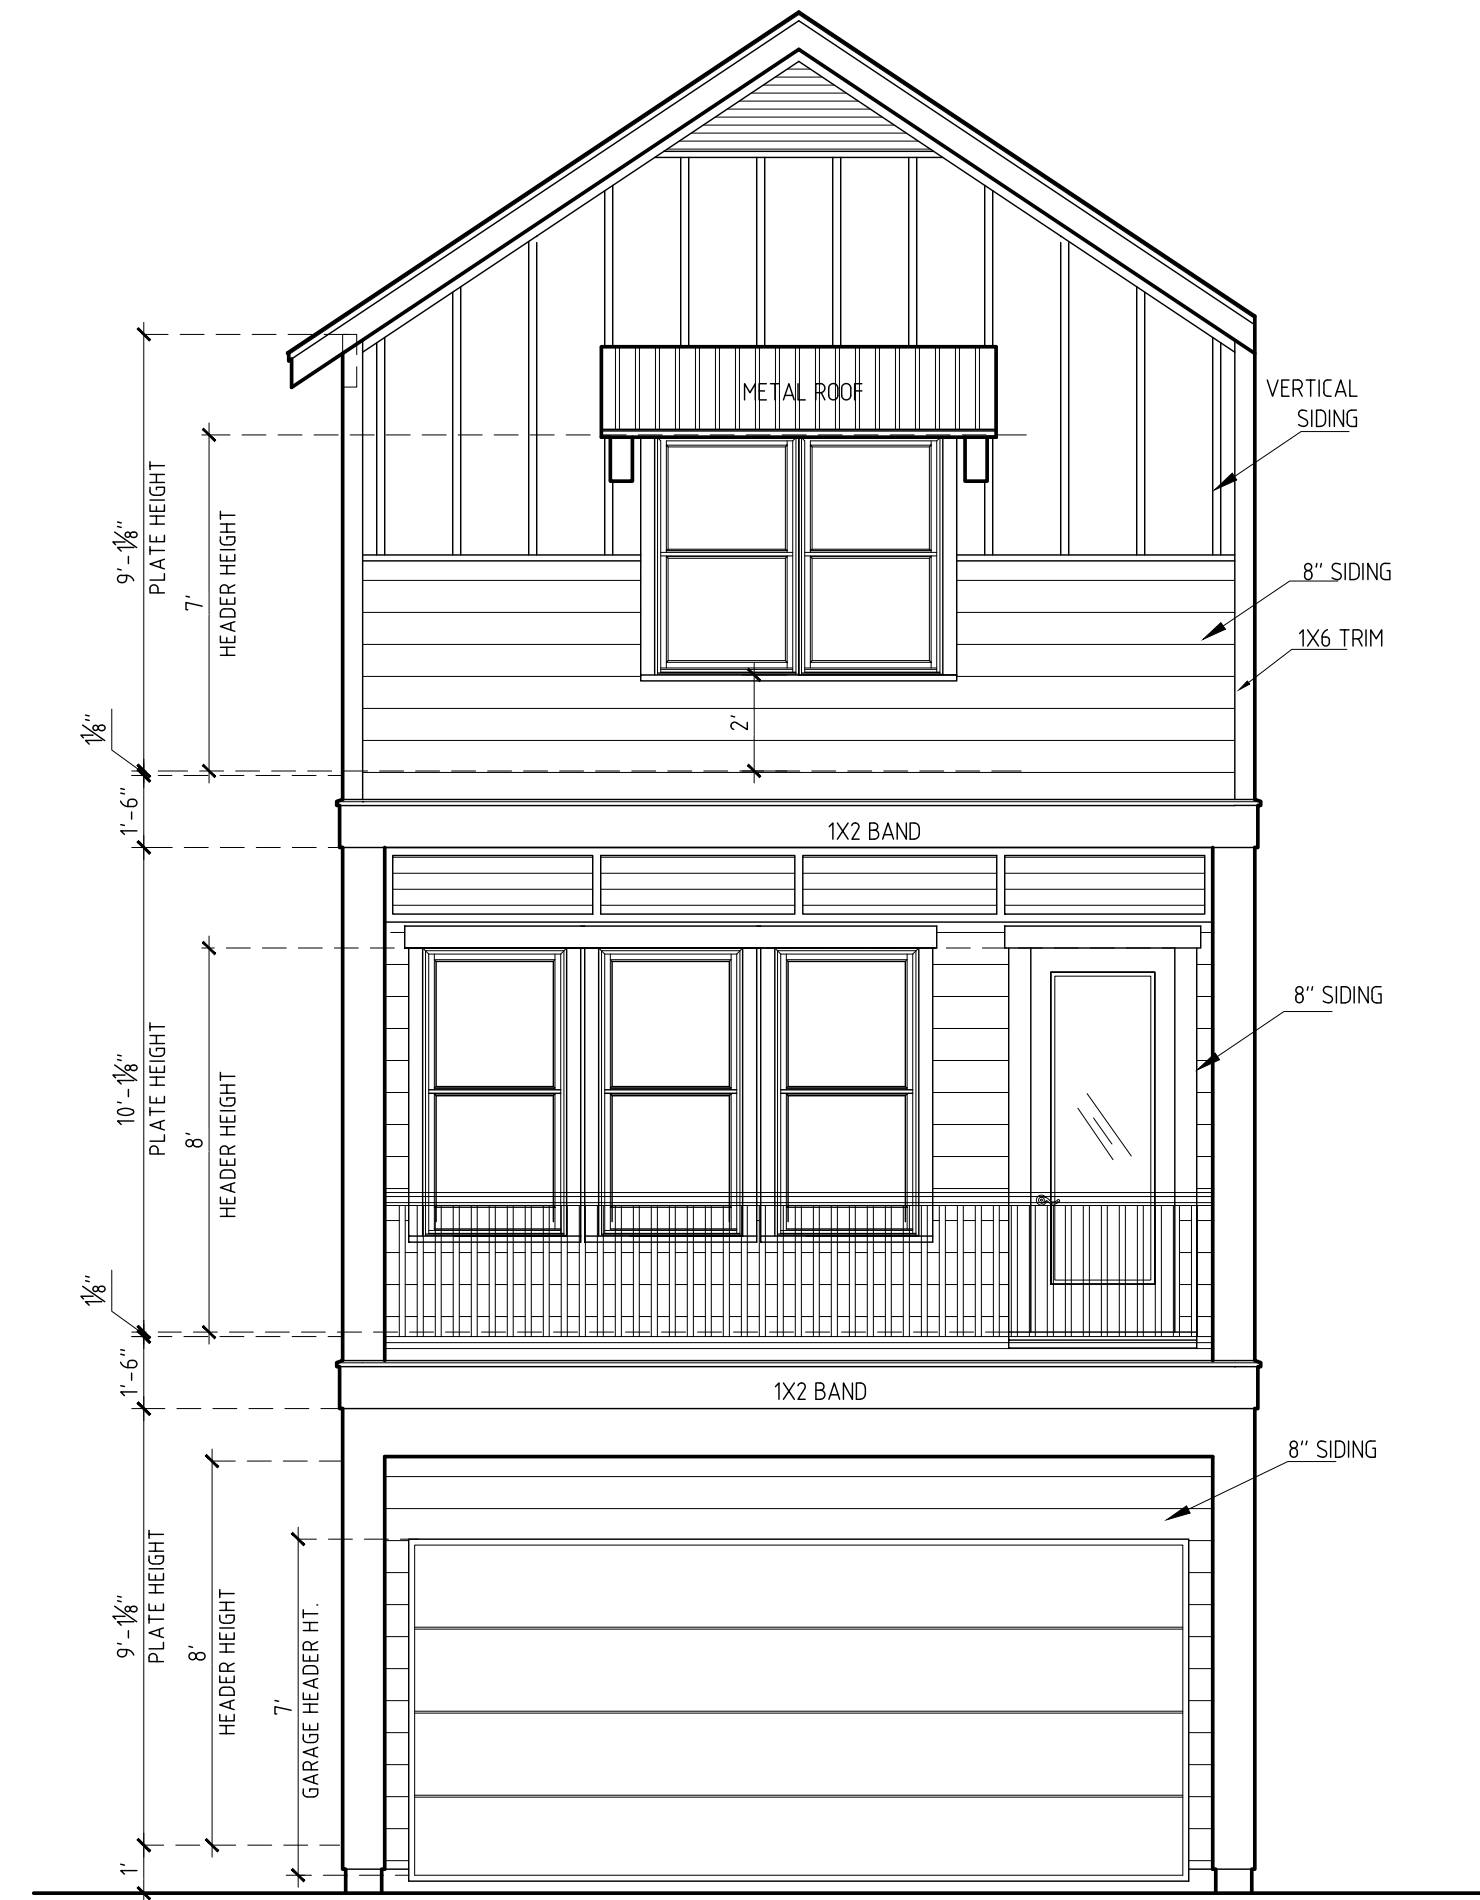
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316 N THORNTON ROAD  
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4605 L YALE STREET  
HOUSTON, TEXAS.

<p>SHEET TITLE</p> <p>EXTERIOR ELEVATIONS</p>
<p>SHEET NO.</p> <p>A2.1</p>







Scale: 1/4"= 1'-0"



Scale: 1/4"= 1'-0"

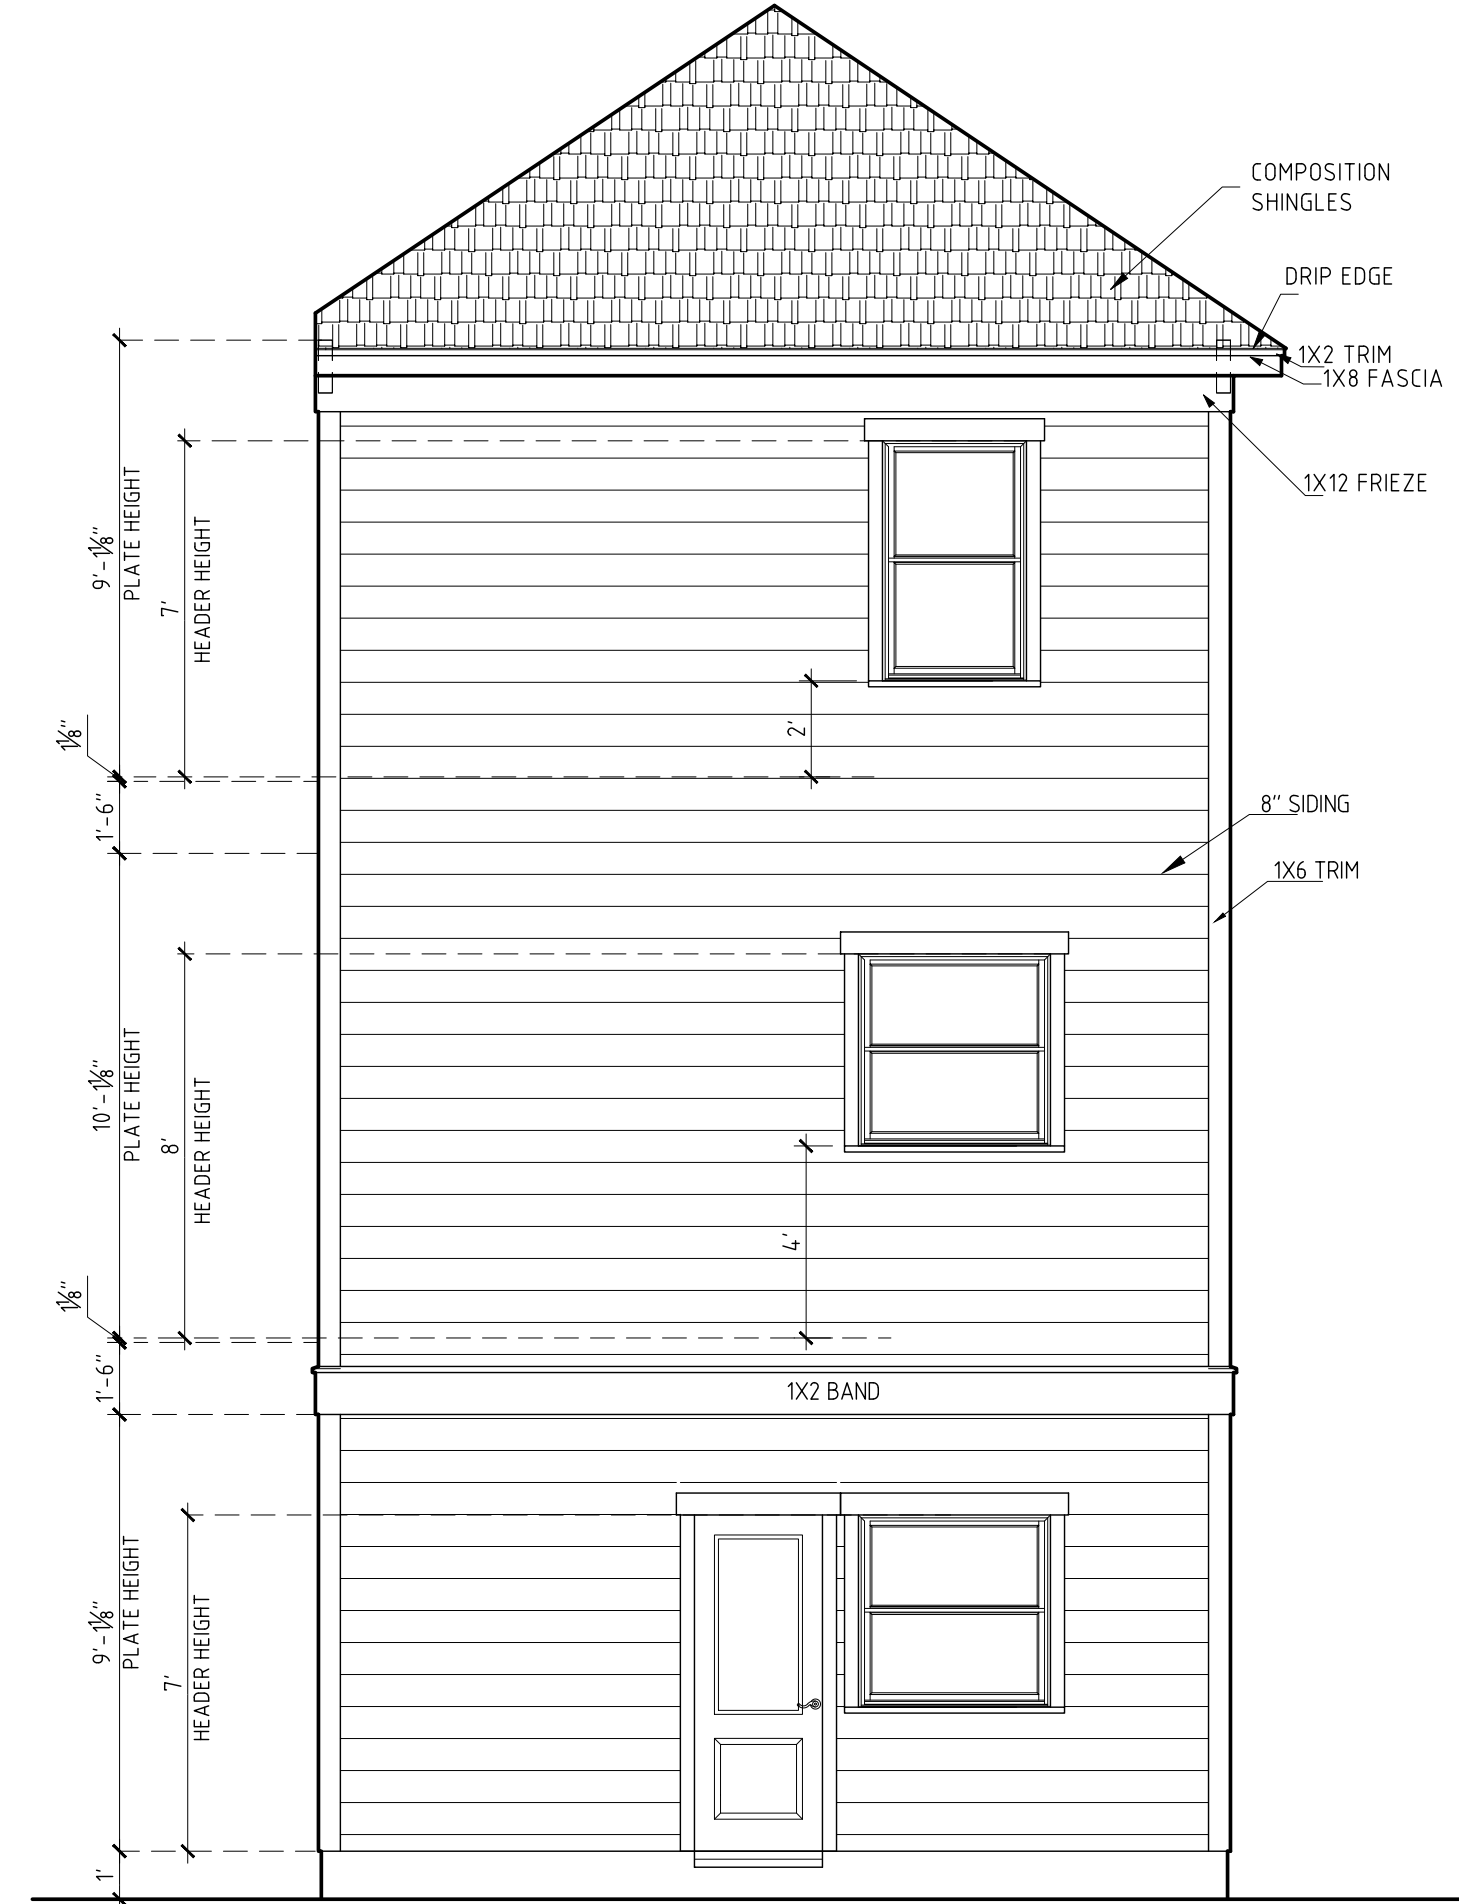

Scale: 1/4"= 1'-0"

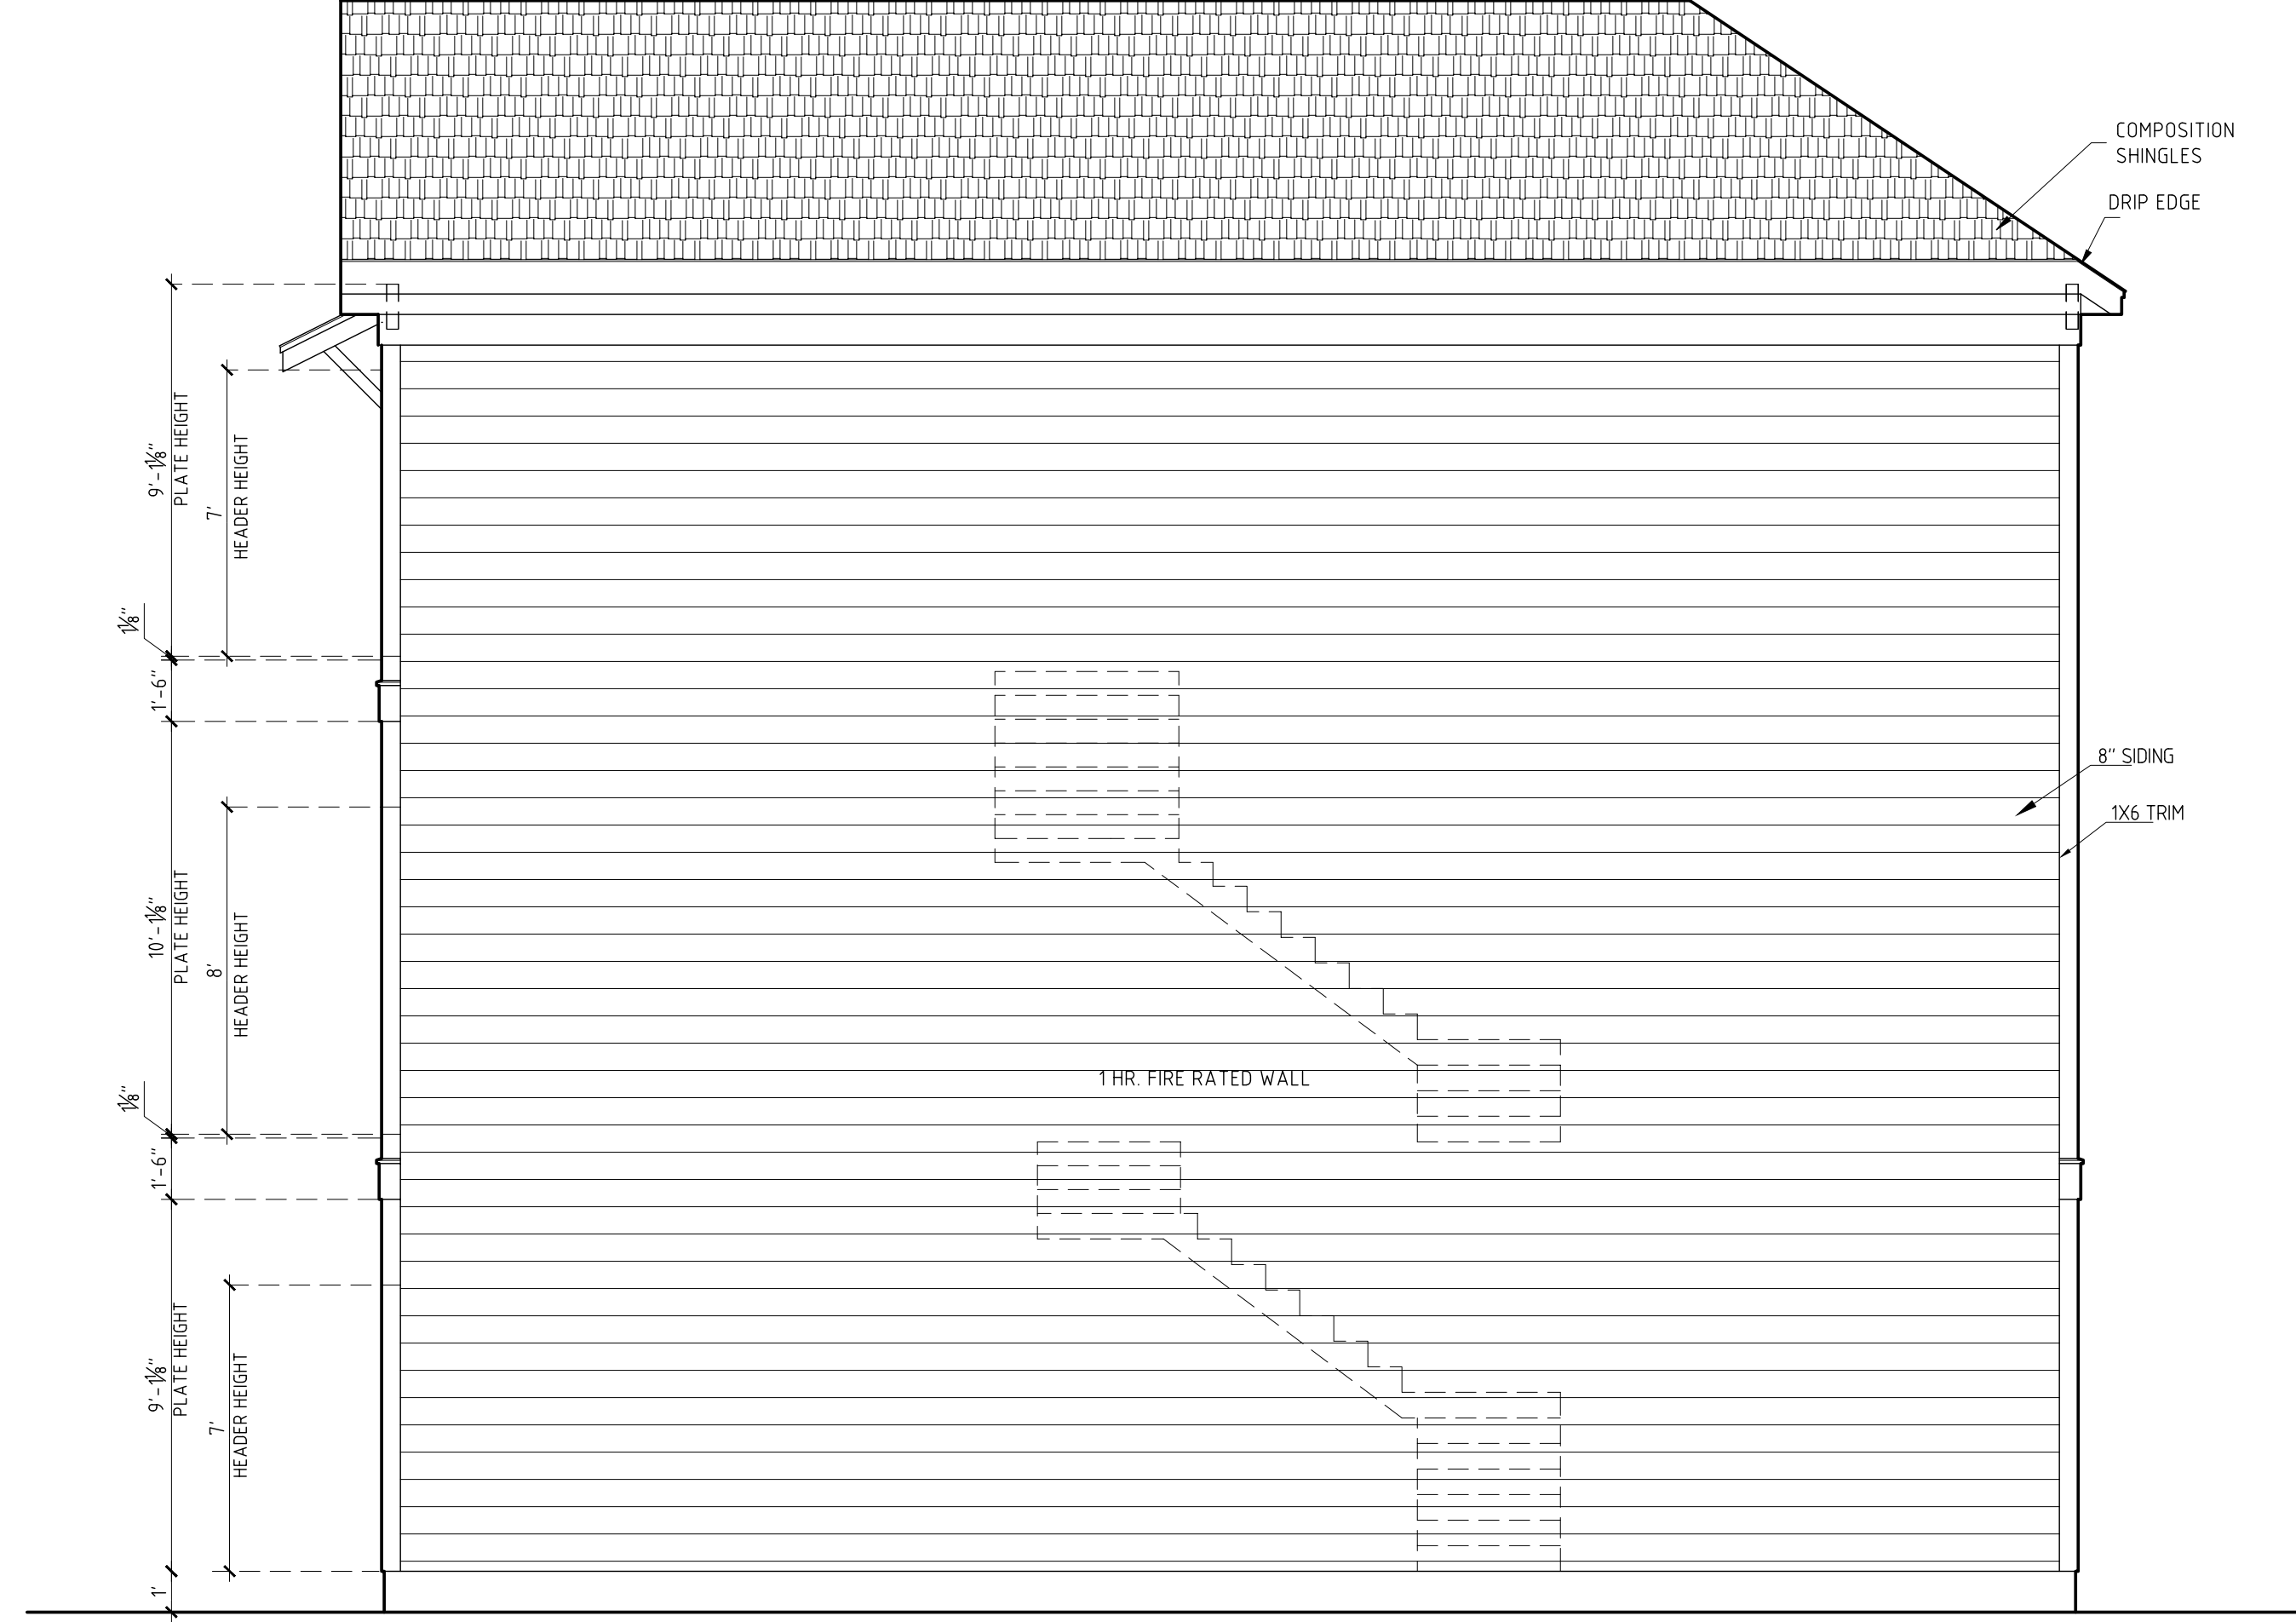

Scale: 1/4"= 1'-0"

SHEET TITLE




EXTERIOR  
ELEVATIONS

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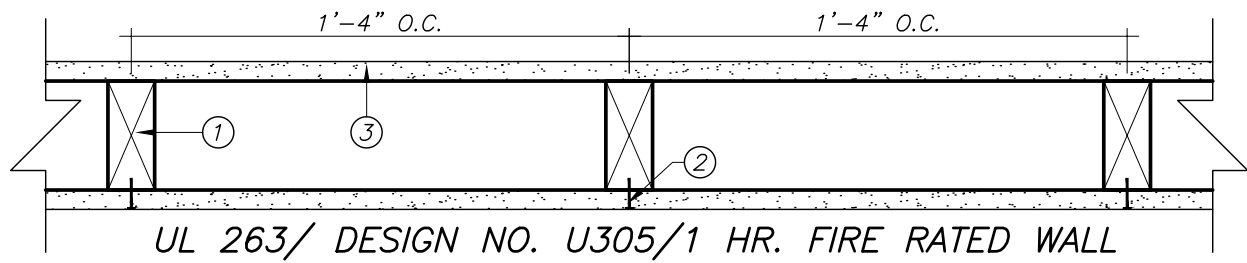






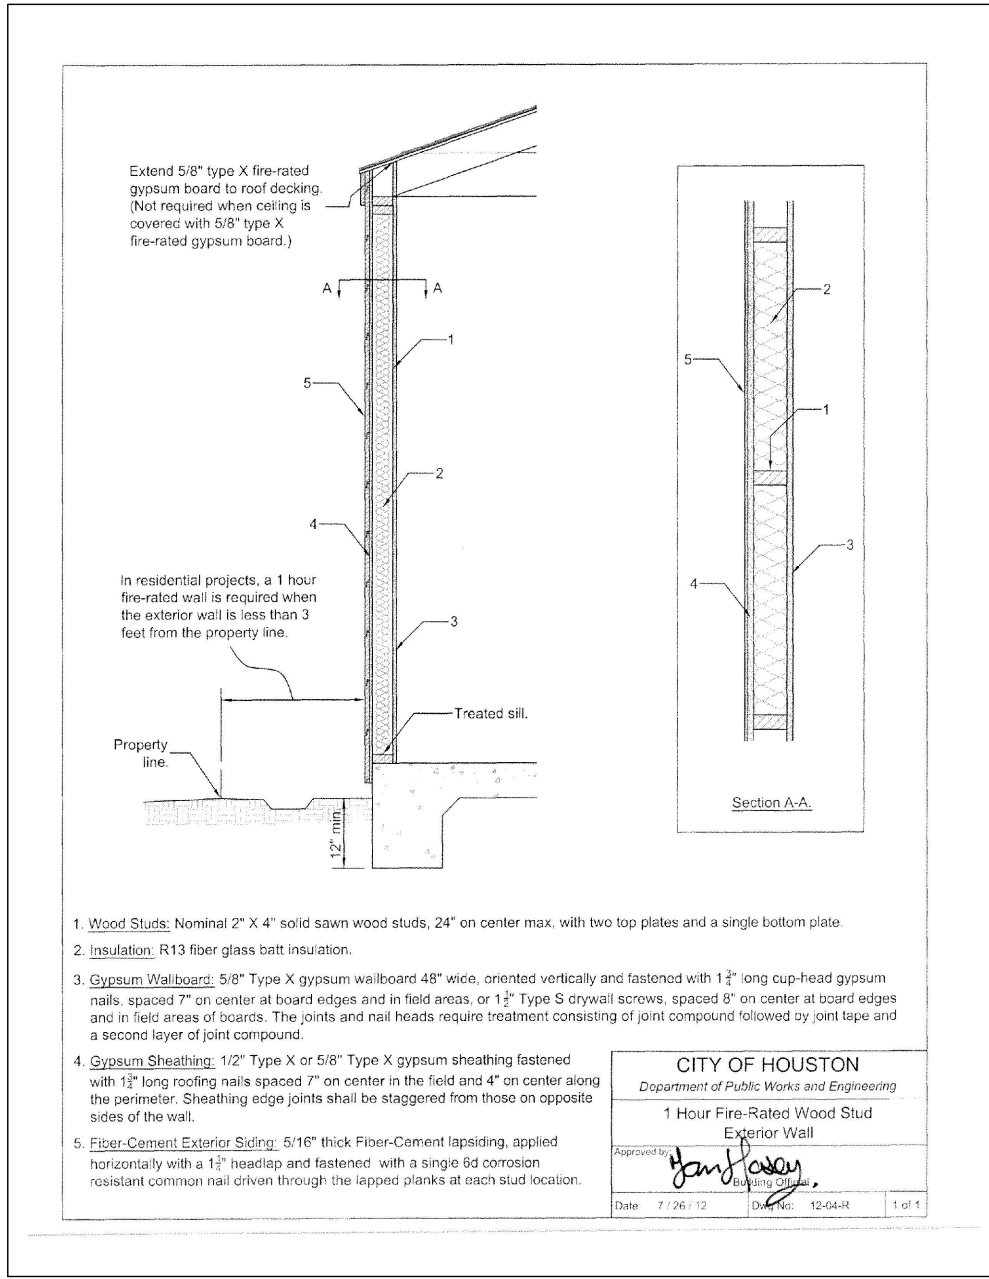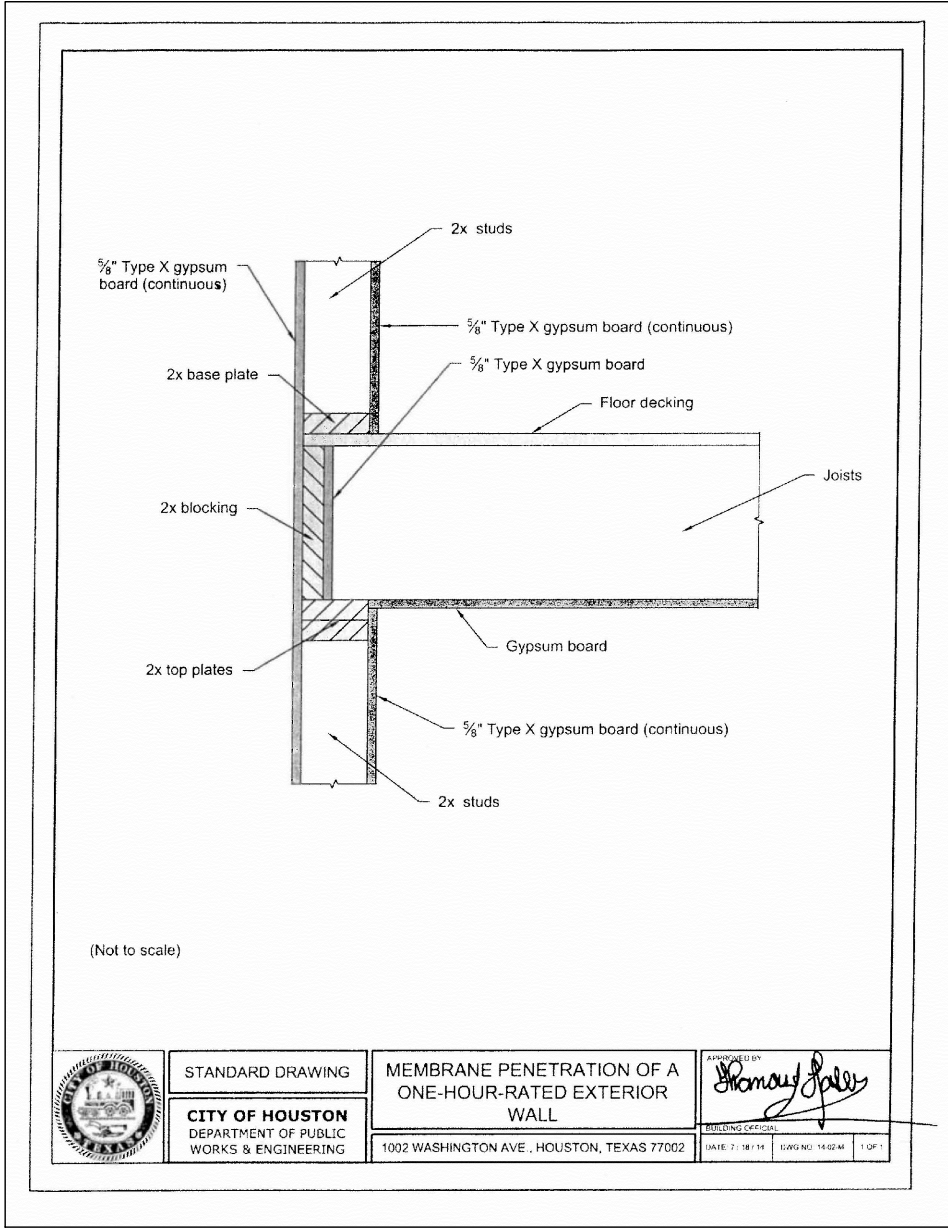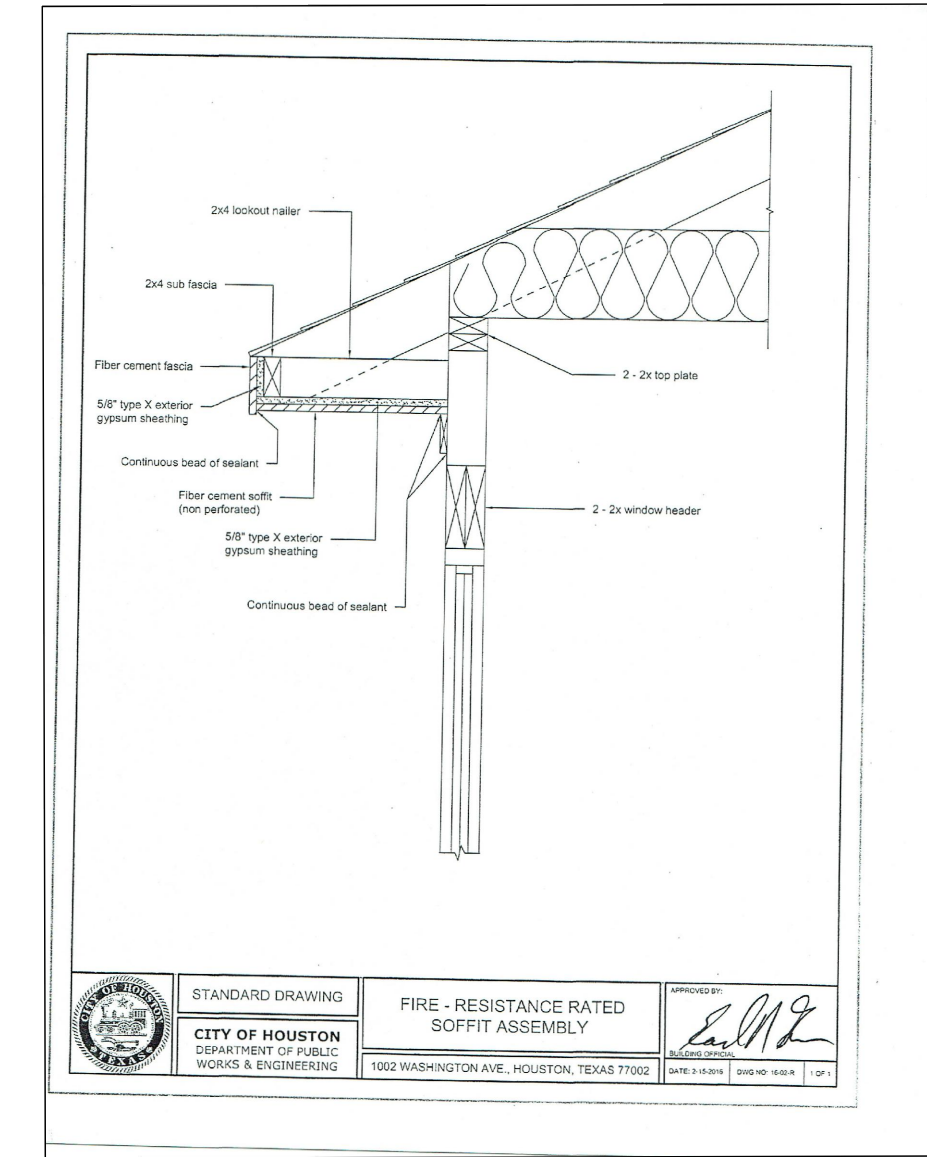

- WALL/FLOOR INSULATION INSTALLED PER MANUFACTURER'S INSTRUCTIONS AND IN SUBSTANTIAL CONTACT WITH THE UNDERSIDE OF THE SUBFLOOR.
- CEILING INSULATION INSTALLED PER MANUFACTURER'S INSTRUCTIONS. BLOWN INSULATION MARKED EVERY 300 FT<sup>2</sup>. (SHEET D12)
- VENTED ATTICS WITH AIR PERMEABLE INSULATION INCLUDE BAFFLE ADJACENT TO SOFFIT AND EAVE VENTS THAT EXTENDS OVER INSULATION. (SHEET D12)
- ATTIC ACCESS HATCH AND DOOR INSULATION ≥R-30 OF THE ADJACENT ASSEMBLY. (SHEET D12)




- 1) WOOD STUDS- NOMINAL 2 BY 4 IN. SPACED 16 IN. OC MAX, EFFECTIVELY FIRESTOPPED.
- 2) JOINTS AND NAIL HEADS- EXPOSED OR COVERED WITH FIBER TAPE AND JOINT COMPOUND, EXCEPT WHERE REQUIRED FOR SPECIFIC EDGE CONFIGURATION. FOR TAPERED, ROUNDED-EDGE GYPSUM BOARD, JOINTS COVERED WITH JOINT COMPOUND OR FIBER TAPE AND JOINT COMPOUND. AS AN ALTERNATE, NOM 3/32 IN. THICK GYPSUM VENEER PLASTER MAY BE APPLIED TO THE ENTIRE SURFACE OF CLASSIFIED VENEER BASEBOARD. JOINTS REINFORCED. NAILHEADS EXPOSED OR COVERED WITH JOINT COMPOUND.
- 3) GYPSUM BOARD- 5/8 IN. THICK PAPER OR VINYL SURFACED, WITH BEVELED, SQUARE, OR TAPERED EDGES, APPLIED EITHER HORIZONTALLY OR VERTICALLY. GYPSUM PANELS NAILED 7 IN. OC WITH 6D CEMENT COATED NAILS 1-7/8 IN. LONG, 0.0915 IN. SHANK DIAM AND 15/64 IN. DIAM HEADS. WHEN USED IN WIDTHS OTHER THAN 48 IN., GYPSUM PANELS ARE TO BE INSTALLED HORIZONTALLY.


## 1 HR FIRE RATED WALL

STAIRS TO BE MIN. 36" IN WIDTH (CLEAR). HANDRAILS SHALL NOT PROJECT MORE THAN 4-1/2" ON EITHER SIDE OF THE STAIRWAY. MIN. CLEAR WIDTH AT THE HANDRAIL SHALL NOT BE LESS THAN 31-1/2" WHERE ONE HANDRAIL IS INSTALLED ON ONE SIDE, AND 27" WHERE HANDRAILS ARE PROVIDED ON BOTH SIDES PER IRC R311.5.1.

PER IRC 2006, GUARDRAILS SHALL BE IN COMPLIANCE WITH THE TABLE R301.5 MIN. UNIFORMLY DISTRIBUTED 200 POUNDS PER SQ. FT. LIVE LOADS APPLIED IN ANY DIRECTION AT ANY POINT ALONG THE TOP OF GUARDRAIL OR HANDRAIL.

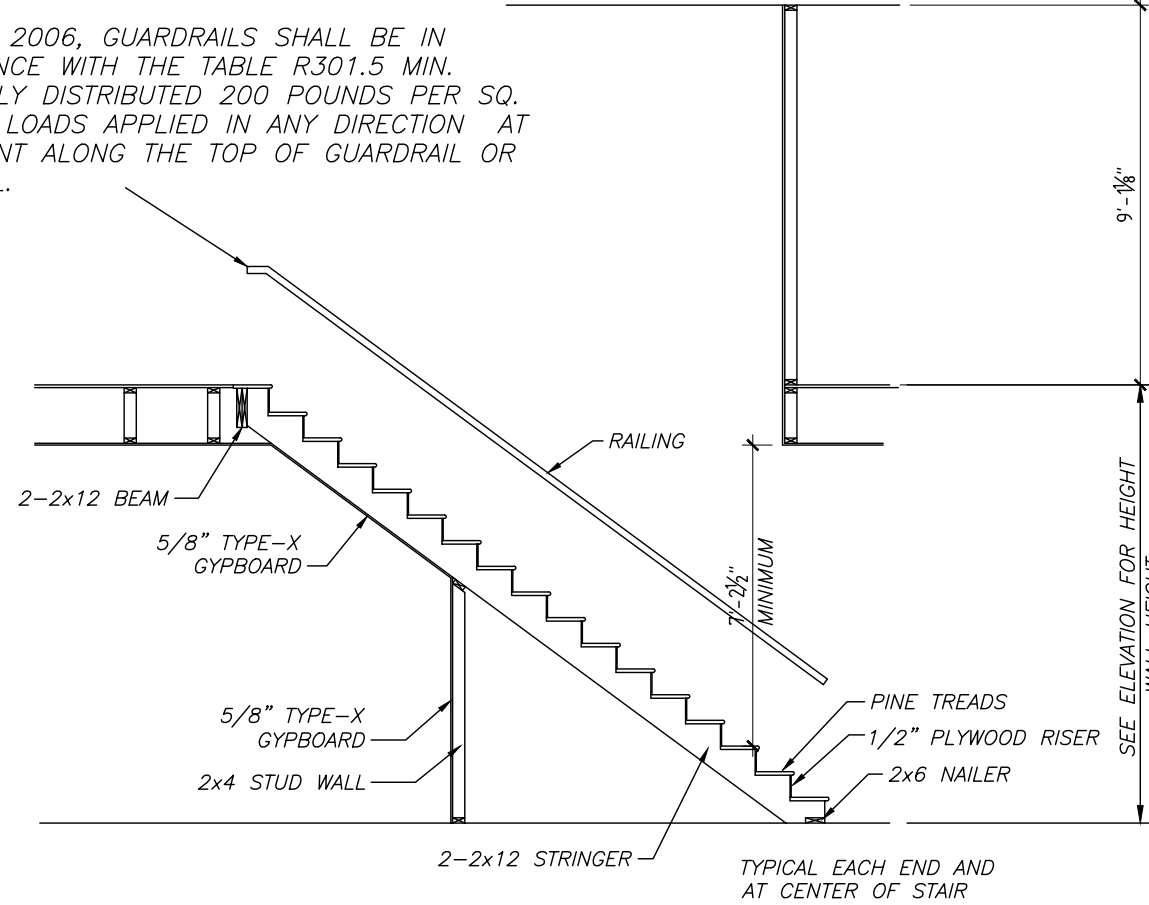


## STAIRS DETAIL

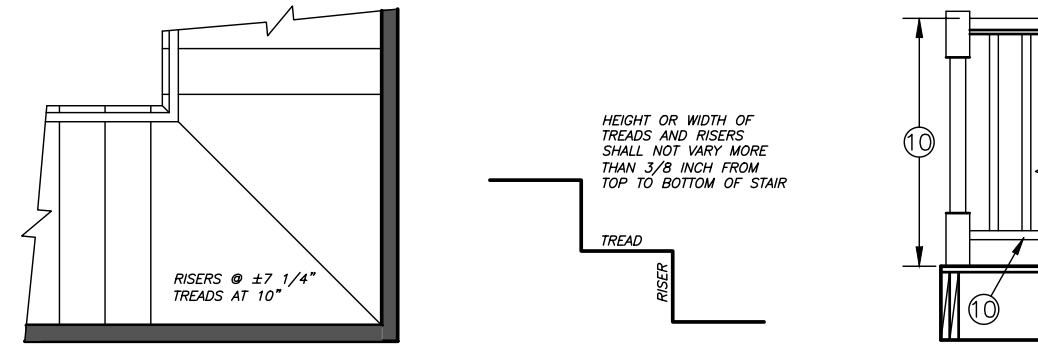

### STAIR AND GUARD NOTES:


- 1) GUARDRAILS SHALL COMPLY WITH IRC 2012, SECT'S. R312, R314, R316, AND R318.
- 2) HANDRAILS TO BE 34" TO 38" ABOVE NOSE OF TREAD (IRC 2012, SECT. R316.1).
- 3) GUARDRAILS AT 34" TO 42" AND 44" AND 46" (IRC 2012, SECT. R316.1.1) SPACE BETWEEN BALUSTERS AT 4" MAX. (IRC 2012, SECT. R316.2).
- 4) HAND GRIPPING PORTION OF HANDRAILS SHALL BE NOT LESS THAN 1 1/4" NOM MORE THAN 2 5/8" IN CROSS SECTION OF THE SHAPE SHALL PROVIDE AN EQUIVALENT GRASPING SURFACE (IRC 2012, SECT. R316.3).
- 5) (ONE) HANDRAIL SHALL BE CONTINUOUS THE FULL LENGTH OF THE STAIRS AND SHALL EXTEND NOT LESS THAN 4" BEYOND THE TOP AND BOTTOM RISERS, AND SHALL TERMINATE INTO A NAIL POST OR SAFETY TERMINAL (IRC 2012, SECT. 316.1.1). HANDRAILS ADJACENT TO A WALL SHALL HAVE A SPACE OF NOT LESS THAN 1 1/2" BETWEEN WALL AND RAIL. HANDRAILS SHALL NOT PROJECT MORE THAN 4 1/2" ON EITHER SIDE OF THE STAIRWAY (IRC 2012, SECT. R316.1).
- 6) IF THE UNDERSIDE OF STAIRWELL IS CLOSED OFF, PROVIDE 5/8" TYPE "X" FIRE RATED GYPSUM BOARD TO THE UNDERSIDE OF STAIRS.
- 7) NAIL POST (THAT RAILING TERMINATES INTO) SHALL BE LOCATED NO HIGHER THAN THE FIRST TREAD.
- 8) MINIMUM CLEAR WIDTH BETWEEN (AND BELOW) HANDRAILS SHALL BE 27" (DOUBLES) AND 21 1/2" (SINGLE RAIL). SEE IRC 2012, SECT. R314.1.
- 9) INTERIOR GUARDS SHALL NOT BE CONSTRUCTED WITH HORIZONTAL RAILS OR OTHER ORNAMENTAL PATTERN THAT RESULTS IN A LANDER EFFECT. SEE IRC 2012, SECT. R316.2.
- 10) EXTERIOR GUARDS TO HAVE RAILING NO LOWER THAN 42" FROM FINISHED FLOOR, WITH NO LESS THAN 36" DISTANCE FROM TOP OF GUARD TO BOTTOM OF LONGEST RUNNER. MAXIMUM UNSUPPORTED SPAN OF LONGEST RUNNER SHALL BE 6'-0".
- 11) MAXIMUM RISER HEIGHT IS 7 1/4". MAXIMUM TREAD DEPTH IS 10" (IRC 2012, SECT. R314.2).
- 12) MAXIMUM HEADROOM IN ALL PARTS OF THE STAIR SHALL NOT BE LESS THAN 6'-8" (FINISHED HEIGHT) MEASURED VERTICALLY FROM SLOPED PLANE ALONGING THE TREAD RISING OF FROM THE FLOOR SURFACE OF THE LANDING OR PLATFORM (IRC 2012, SECT. R314.3).

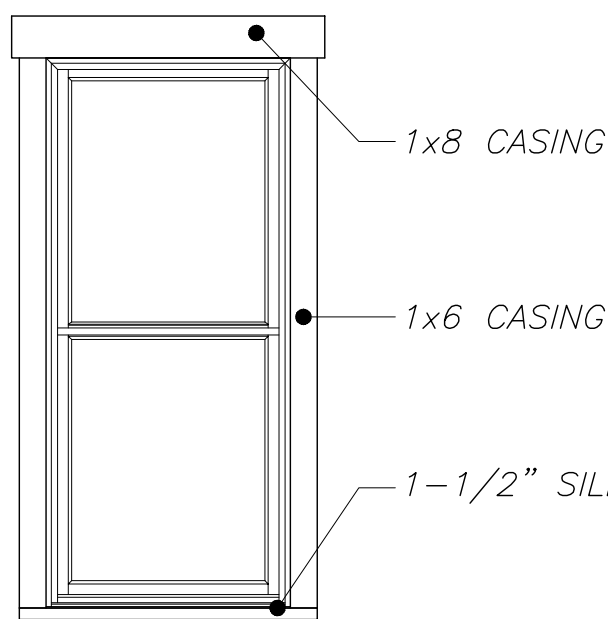

## STAIRS DETAIL


## WINDOW DETAIL

## 6 EAVE DETAIL


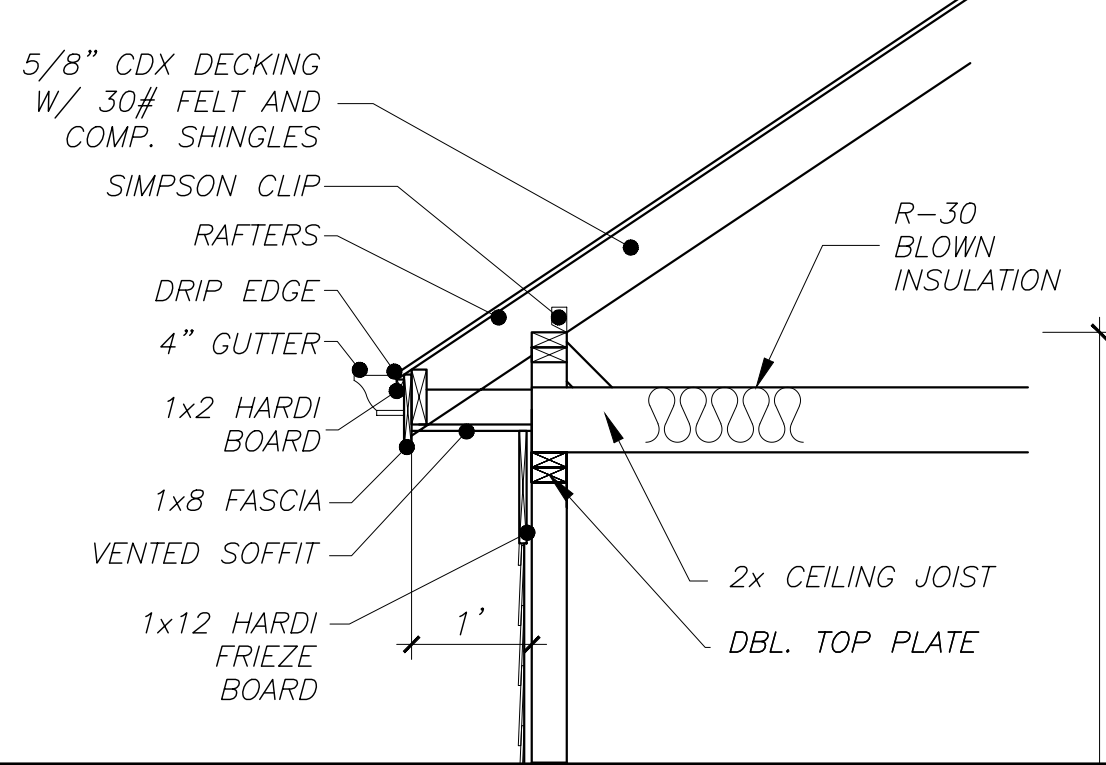


## 6 EAVE DETAIL

## 7 FOUNDATION

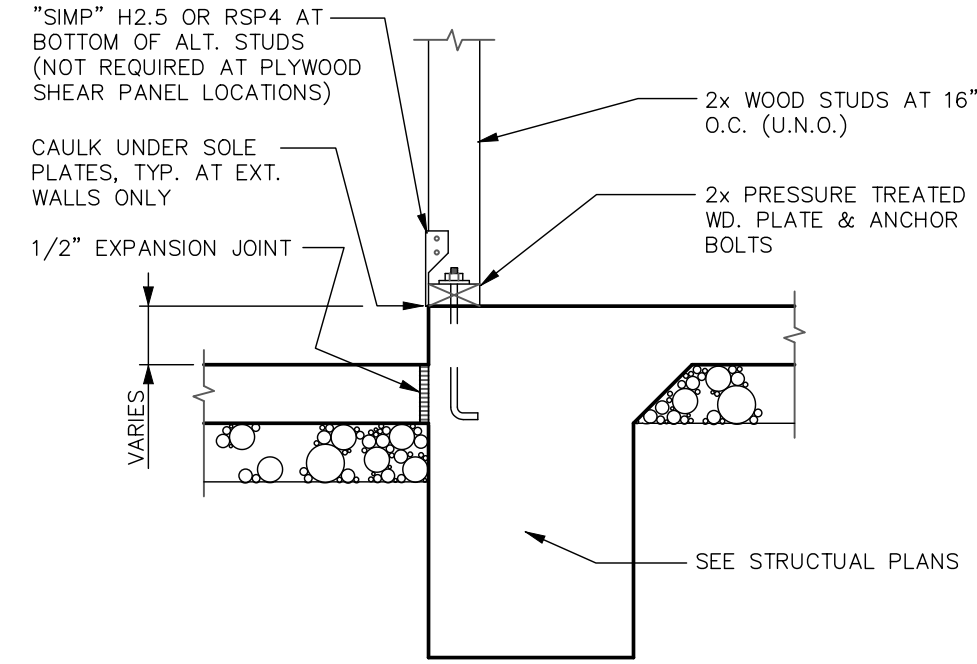

## 7 FOUNDATION

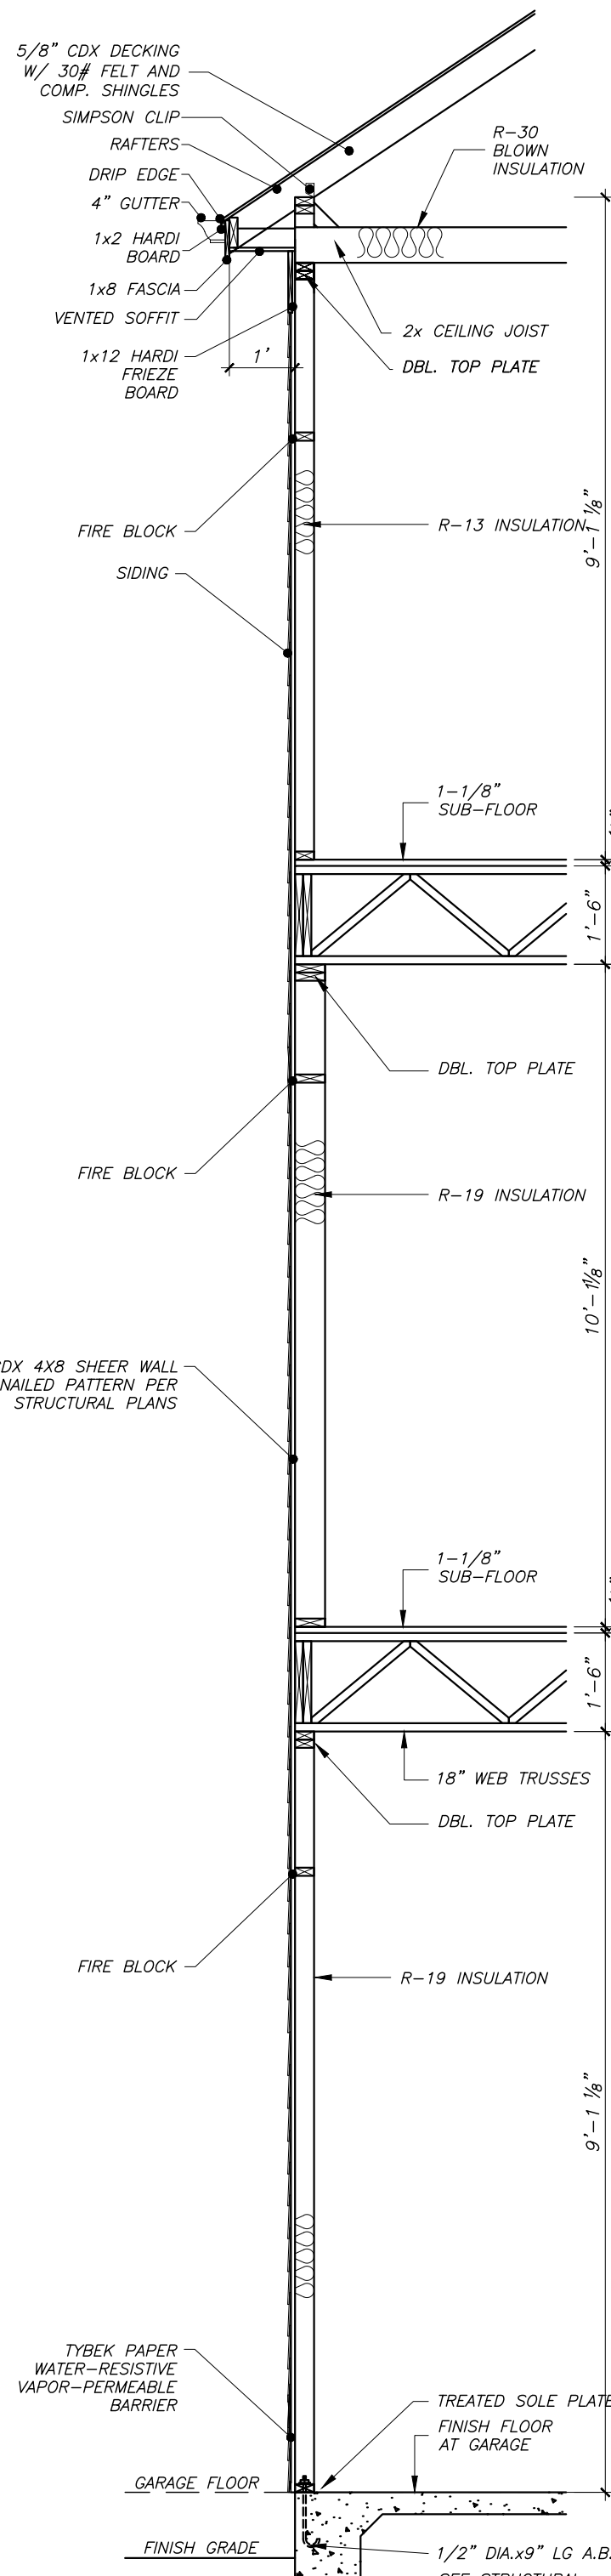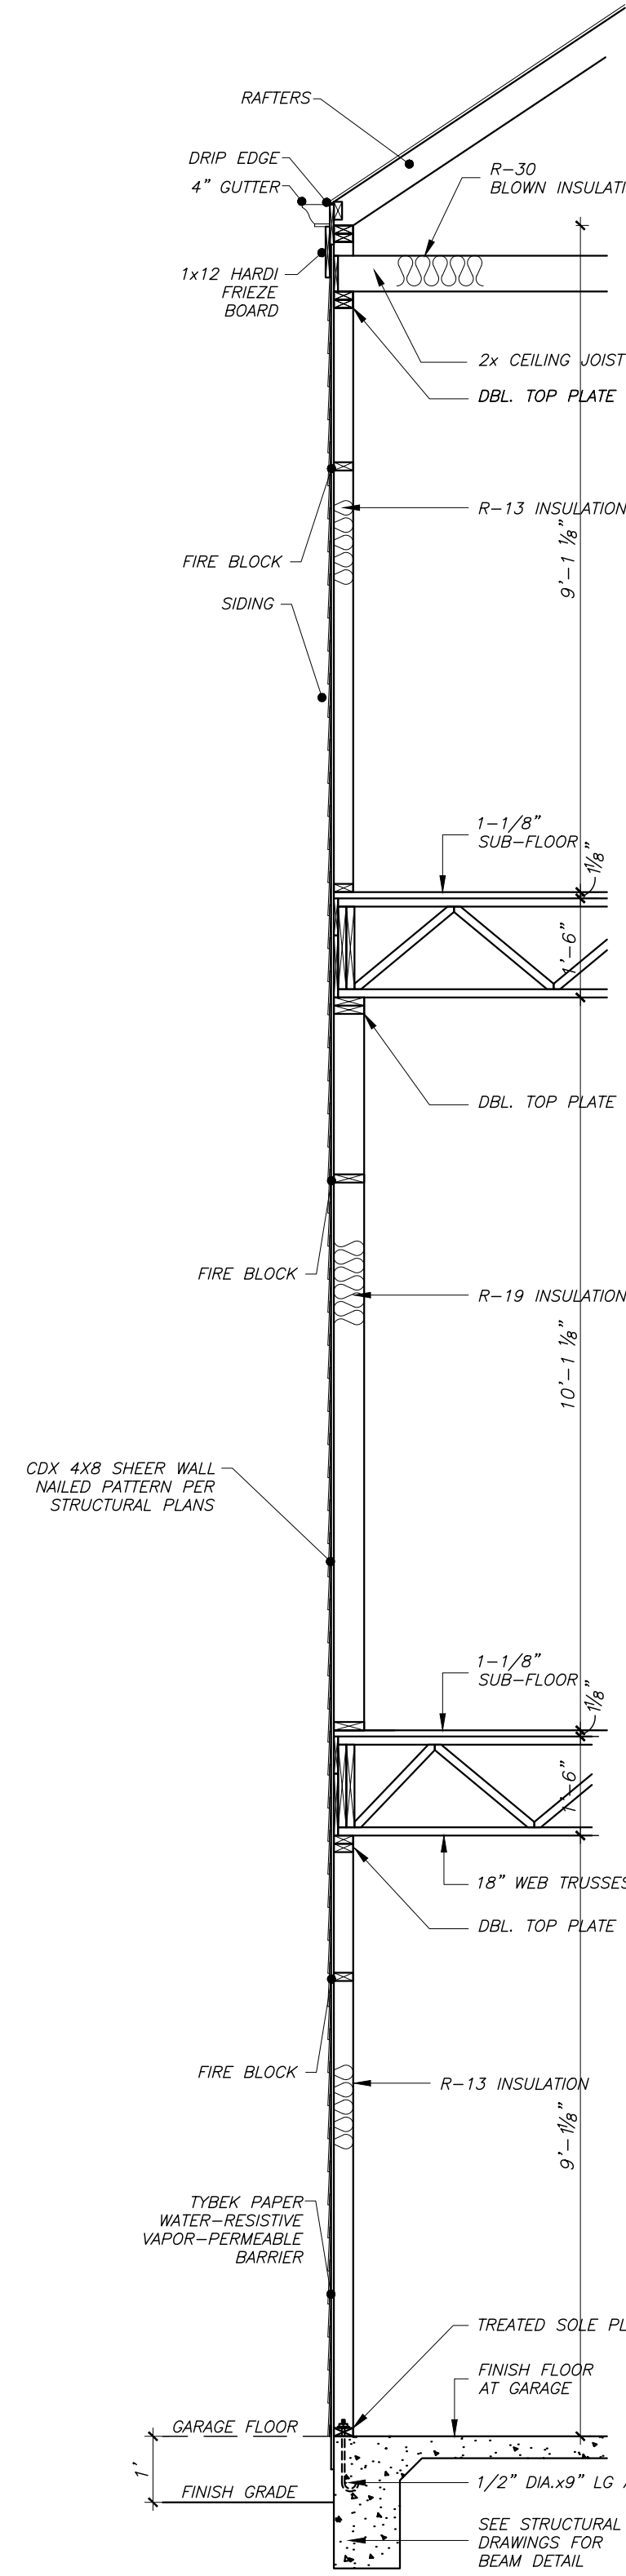

D&Q design

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DETAILS & NOTES
















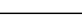
















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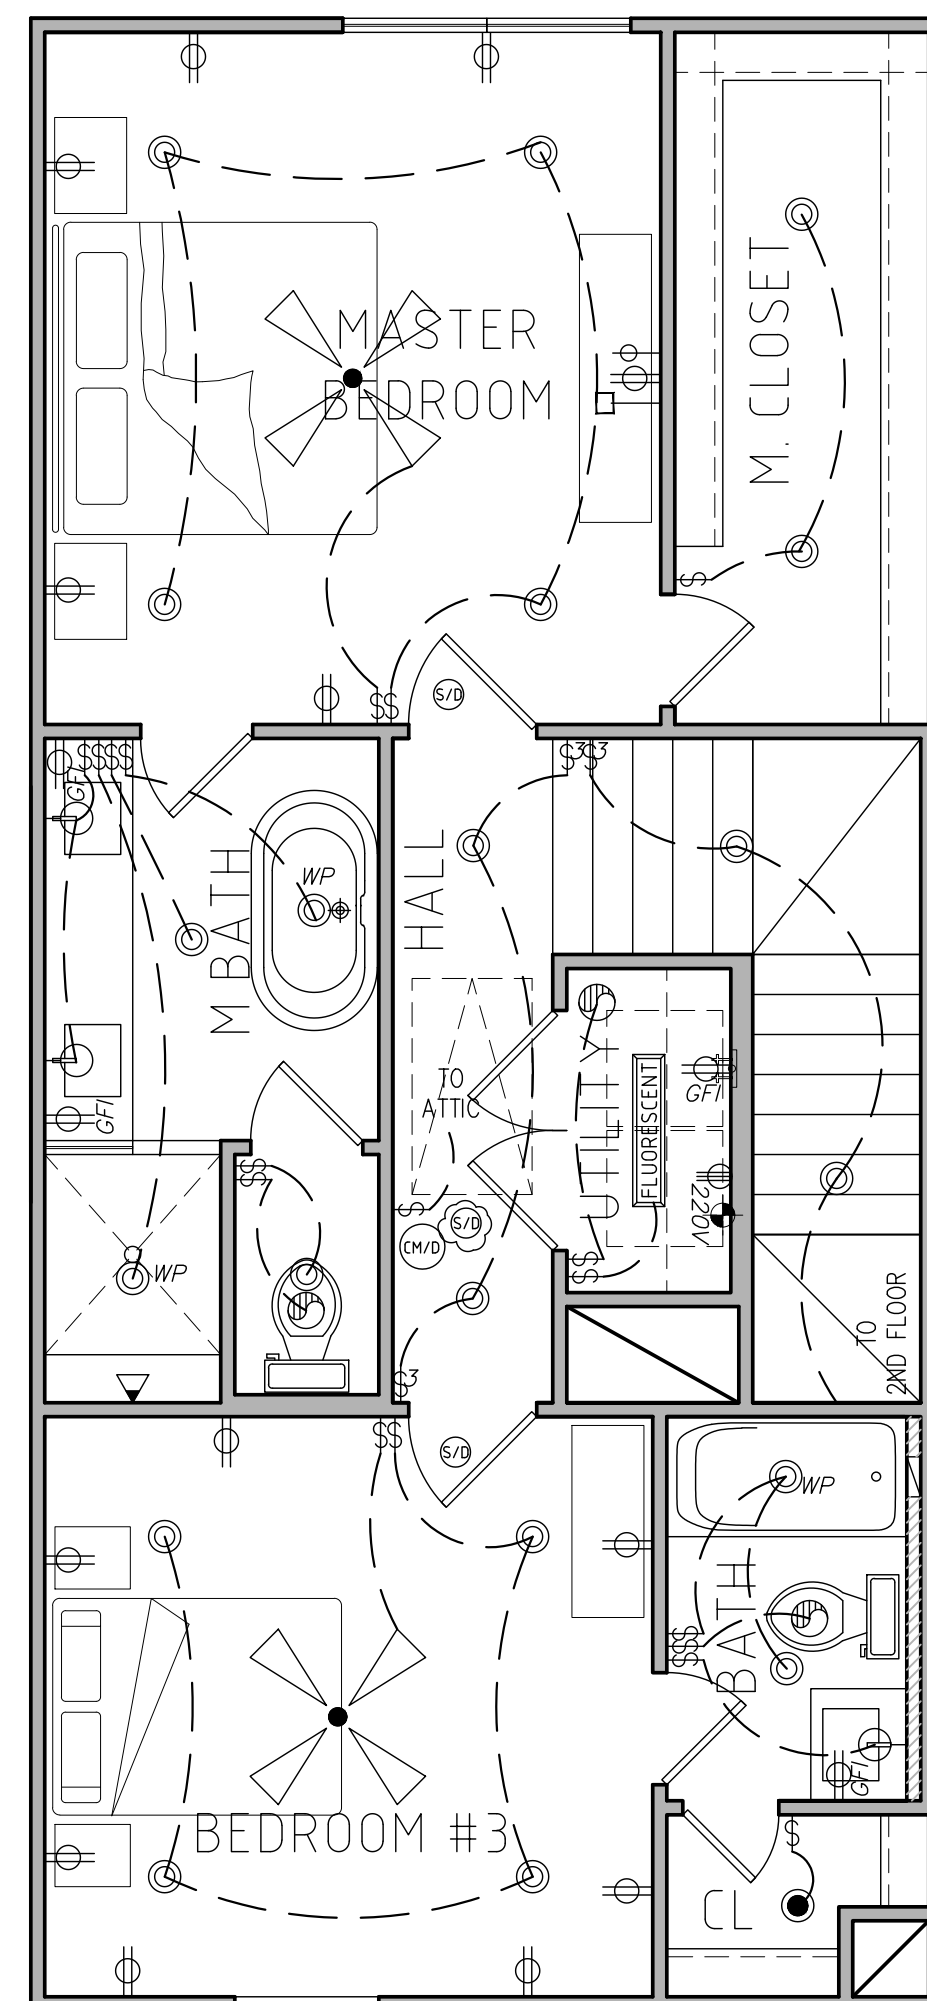


NOTE: SEE LANDSCAPE  
PLAN FOR OUTSIDE  
OUTLETS

BLOCK-OUT ALL  
SWITCHES  
FOR 1x8 TRIM


ELECTRICAL NOTES		ELECTRICAL LEGEND	
1) GAS WATER HEATER		 SINGLE POLE SWITCH	 FAN
2) HARD WIRE HOUSE FOR SECURITY SYSTEM. SECURITY SYSTEM TO BE SELECTED BY OWNER	 110 VOLT RECEPTACLE	 THREE WAY SWITCH	 OUTSIDE FAN
3) SECURITY SYSTEM WILL BE INSTALLED PRIOR TO APPLICATION OF DRY WALL AND ACCORDING TO MANUFACTURERS SPEC. AS NEGOTIATED BY OWNER UNDER SEPARATE CONTRACT.	 110 V. IN FLOOR	 FOUR WAY SWITCH	
	 120V 110 V/0 GROUND FAULT INTERRUPTER	 DIMMER SWITCH	
4) SMOKE DETECTORS TO BE HARDWIRED INTO-CONNECTED WITH BATTERY BACKUP REQUIRED BY THE INC.	 CABLE	 PENDANT LIGHT	 CEILING MOUNT FIXTURE
	 GAS OUTLET	 LV LOW VOLTAGE	 EXHAUST FAN
	 TELEPHONE OUTLET	 HANGING LIGHT	 EXHAUST FAN W/ LIGHT KIT
5) MIN. 2 LIGHTS IN EACH ATTIC AREA.	 JAMB SWITCH	 4" RECESSED CAN LIGHT	 WALL MOUNTED LIGHT
	 FLOODS ON PHOTO CELL	 WATERPROOF RECESSED CAN LIGHT	 WALL MOUNTED PHOTO CELL LIGHT
	 UNDER CAB. STRIP LIGHT	 SMOKE DETECTOR	 HOSE BIB
	 HELM CABLE	 CARBON MONOXIDE DETECTOR	 FLUORESCENT FIXTURE
		 HANGING GAS LIGHT	 THERMOSTAT

- I-CRATED RECESSED LIGHTING FIXTURES SHALL BE RATED WITH A LEAKAGE RATE OF LESS THAN 42.0 CFM AT 75 PA.  
 AUTOMATIC EXHAUST DAMPERS TO BE INSTALLED ON ALL OUTDOOR AIR INTAKES AND EXHAUSTS.  
 THE DOWELLING JUNT SHALL HAVE A BLOWER DOOR TEST. THE BLOWER DOOR TEST IS 80 PA. SHALL BE  $\leq 45$  CFM.  
 RETURN AIRWAYS AND RETURN AIR SHALL BE DUCTED. SUPPLY AND RETURN DUCTS IN ATTICS SHALL INCLUDE  $\geq R-8$  SUPPLY AND RETURN DUCTS IN OTHER PORTIONS OF THE BUILDING INSULATION  $\geq R-6$ .  
 ALL DUCTS DUCT TIGHTNESS TEST FOLLOWING THE MECHANICAL SYSTEMS.  
 PROGRAMMABLE THERMOSTATS INSTALLED FOR CONTROL OF PRIMARY HEATING AND COOLING SYSTEMS.  
 CIRCULATING SERVICE HOT WATER SYSTEMS HAVE AUTOMATIC OR ACCESSIBLE MANUAL CONTROLS.  
 EXHAUST AND RANGE HOODS SHALL MEET THE EFFICIENCY REQUIREMENTS OF TABLE R403.0.1 OF THE IECC.  
 HUNGRY SYSTEM SHALL BE SIZED PER ACCA MANUAL J OR OTHER APPLICABLE METHOD.  
 HEATED WATER CIRCULATION SYSTEMS SHALL BE PROVIDED IN ACCORDANCE WITH TABLE R403.0.1, 1.4. MECHANICAL CONTROLS AND BE PROVIDED WITH A CIRCULATION PUMP. THE RECIRCULATION PUMP SHALL LIMIT THE TEMPERATURE OF THE WATER ENTERING THE COLD WATER PIPING TO 100°F. HVAC PIPING CONNECTING FLOORS ABOVE .005 PSF OR CHILLED FLOORS BELOW .55 PSF OF THE FLOOR SHALL BE .005 PSF. THE INSULATION SHALL BE PROTECTED PER SECTION 403.0.1.4 OF THE IECC.  
 HOT WATER PIPES ARE INSULATED TO R-8.  
 ALL CHILLED WATER PIPES PERMANENTLY INSULATED TO 75% OF PERMANENT FIXTURES HAVE HIGH EFFICIENCY FLANGE PER SECTION 404.1 OF THE IECC.  
 FUEL GAS LIGHTING SYSTEMS HAVE NO CONTINUOUS FLOW LIQUID.  
 USE CONTRACTORS TO PROVIDE CONSTRUCTION DOCUMENTS IN COMPLIANCE WITH IECC.




### THIRD FLOOR PLAN

Scale: 1/4"= 1'-0"

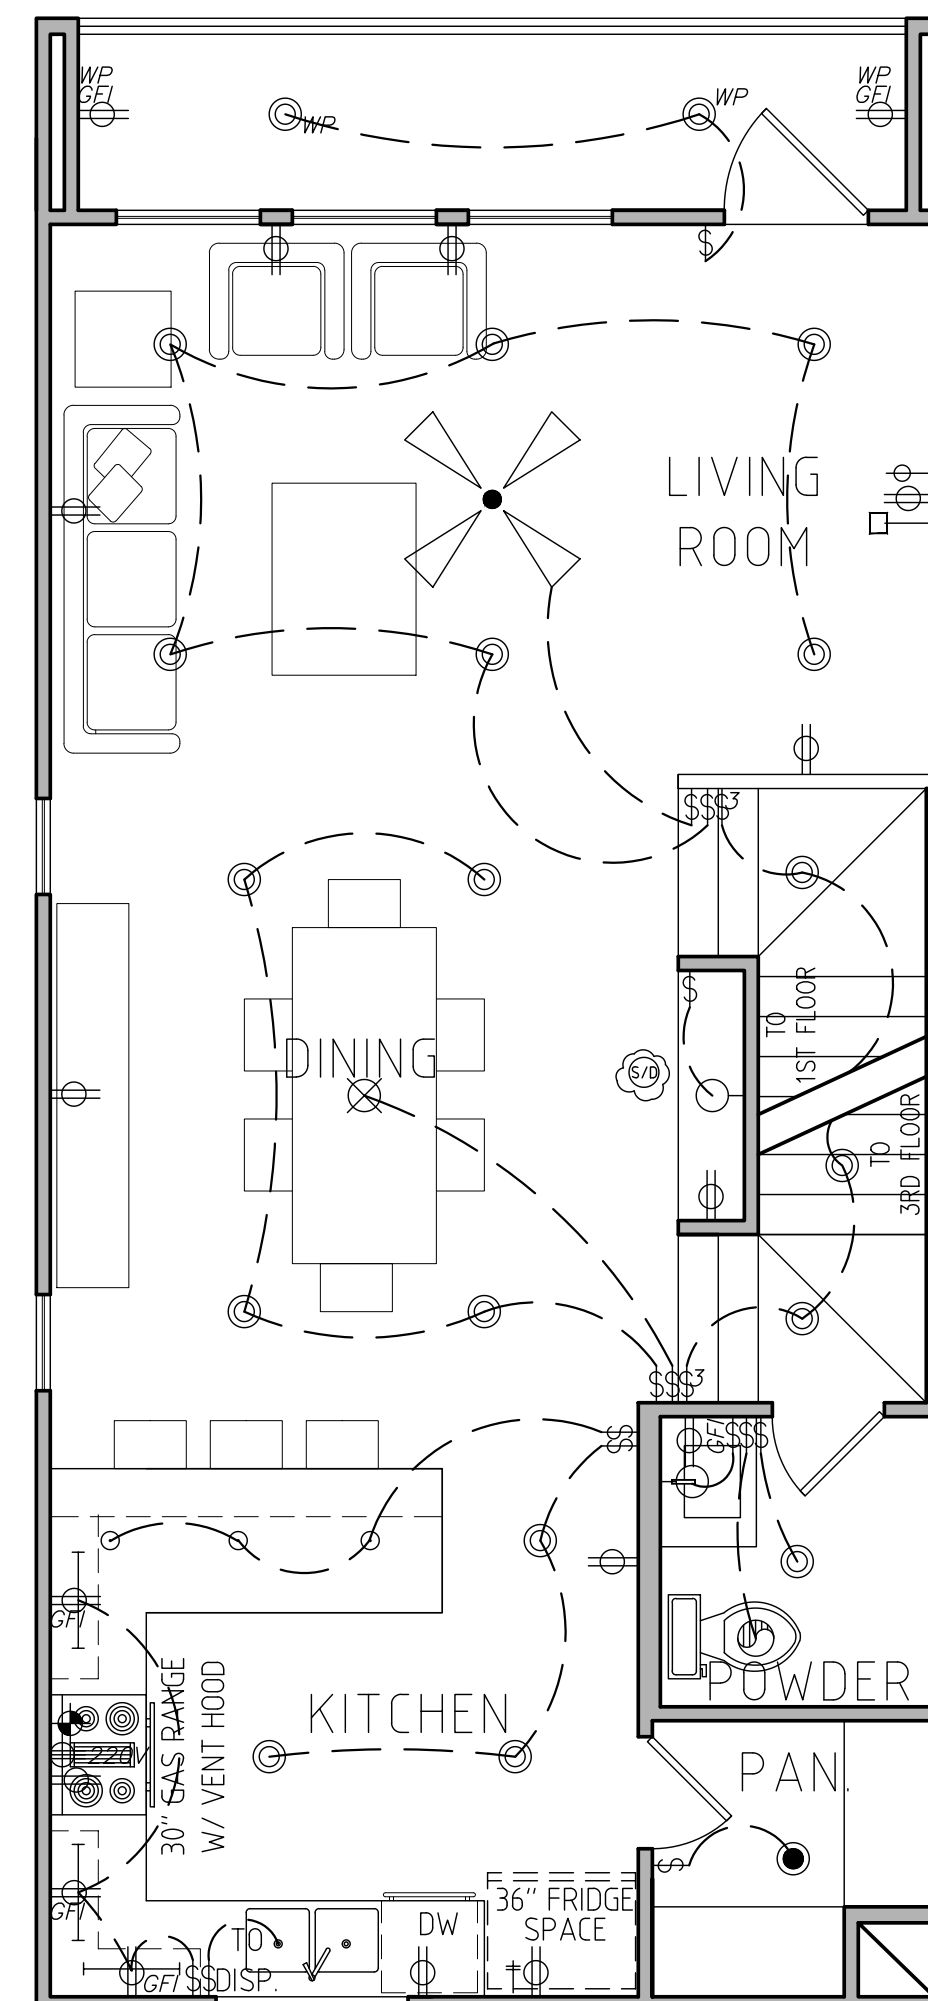

## SECOND FLOOR PLAN

Scale: 1/4" = 1'-0"

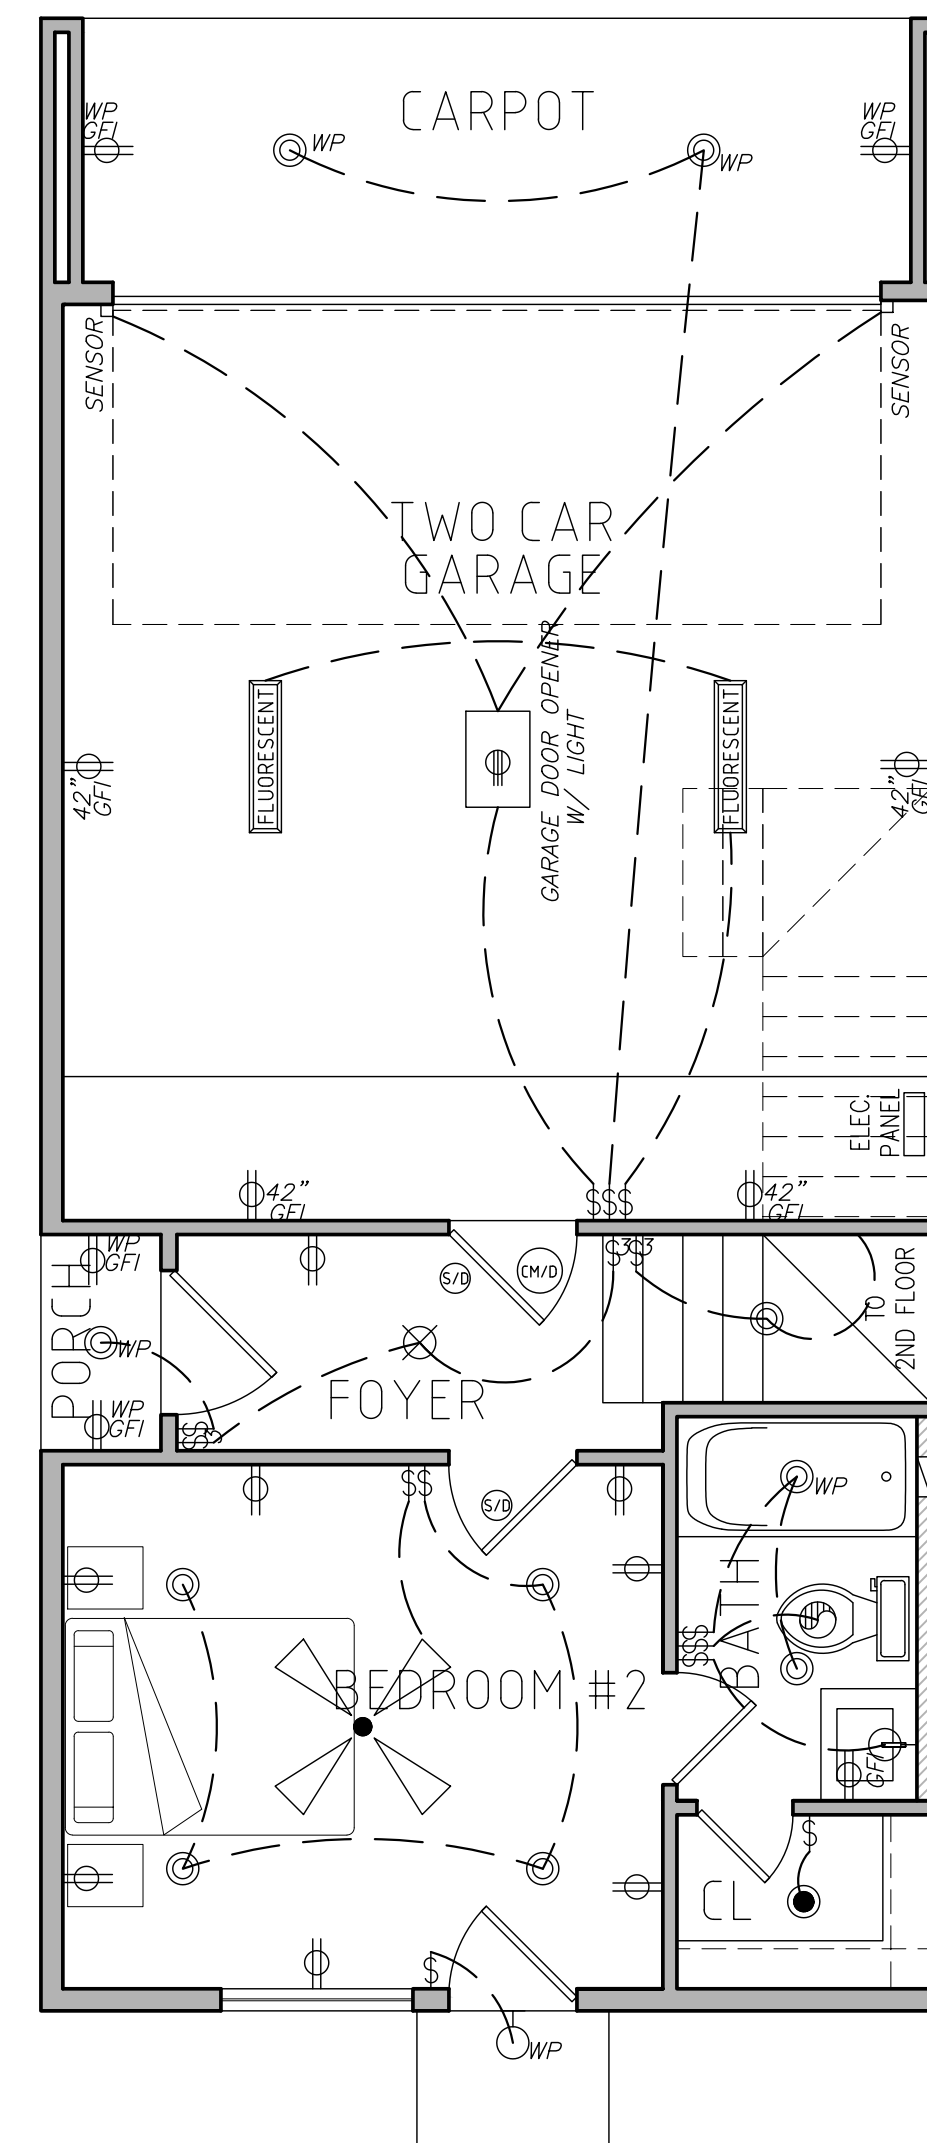

FIRST FLOOR PLAN  
Scale: 1/4"= 1'-0"

LANDING AT YALE  
316 A, 316 I, 316 J, 316 K, 316 L, 316 M &  
316 N THORNTON ROAD  
4605B, 4605C, 4605D, 4605E, 4605F &  
4605L YALE STREET  
HOUSTON, TEXAS.

SHEET TITLE


ELECTRICAL  
PLANS

SHEET NO.


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NOTE: SEE LANDSCAPE  
PLAN FOR OUTSIDE  
OUTLETS


ELECTRICAL NOTES		ELECTRICAL LEGEND	
1) GAS WATER HEATER	① 110 VOLT RECEPTACLE	⚡ SINGLE POLE SWITCH	 FAN 42° OUTSIDE FAN
2) HARD WIRE HOUSE FOR SECURITY SYSTEM, SECURITY SYSTEM TO BE SELECTED BY OWNER	② WATERPROOF RECEPTACLE	⚡ THREE WAY SWITCH	
	③ FLR IN FLOOR	⚡ FOUR WAY SWITCH	
3) SECURITY SYSTEM WILL BE INSTALLED PERMIT TO APPLICATION OF DRY WALL AND ACCORDING TO MANUFACTURER'S SPEC'S AS NOTICED BY OWNER UNDER SEPARATE CONTRACT	④ 110 VOLT W/ GROUND FAULT INTERRUPTER	⚡ DIMMER SWITCH	
	⑤ 220V 220V VOLT RECEPTACLE	⚡ PENDING LIGHT	⦿ CEILING MOUNT FIXTURE
4) SMOKE DETECTORS TO BE HARDWIRED WITH--CONNECTED WITH BATTERY BACK-UP AS REQUIRED BY THE IRC.	— GABE	⚡ LOW VOLTAGE	⦿ EXHAUST FAN
	Ⓢ GAS OUTLET	⚡ HANGING LIGHT	⦿ EXHAUST FAN W/ LIGHT KIT
	Ⓢ TELEPHONE OUTLET	⚡ 4" RECESSED CAN LIGHT	⦿ WALL MOUNTED LIGHT
5) MIN. 2 LIGHTS IN EACH ATTIC AREA.	Ⓢ JAMB SWITCH	⚡ WATERPROOF RECESSED CAN LIGHT	⦿ WALL MOUNTED PHOTO CELL LIGHT
	⦿ FLOODS ON PHOTO CELL	⚡ SMOKE DETECTOR	⦿ HOSE BIB
	— UNDER CAB STRIP LIGHT	⦿ CARBON MONOXIDE DETECTOR	⦿ FLOURESCENT FIXTURE
	— HEMI CABLE	⦿ HANGING GAS LIGHT	⦿ THERMOSTAT

- IC-RATED RECESSED JOINTLESS FIXTURES SHALL BE RATED WITH A LEAKAGE RATE OF LOWER THAN 2.0 CMH AT 75 PSIA
- AUTOMATIC OR GRAVITY DAMPERS TO BE INSTALLED ON ALL OUTDOOR AIR INTAKES EXHAUSTS
- THE DOWELLING UNIT SHALL HAVE A BLOWER DOOR TEST. THE BLOWER DOOR TEST @ 50 PSIA SHALL BE <+5 ACH
- ALL HVAC SUPPLY AND RETURN AIR SHALL BE DUCTED SUPPLY AND RETURN DUCTS IN ATTIC/CEILING SPACE. R-8 SUPPLY AND RETURN DUCTS IN OTHER PORTIONS OF THE BUILDING INSULATED >+R-6
- PROVIDE DUCT TIGHTNESS TEST FOR HVAC SYSTEMS
- PROGRAMMABLE THERMOSTATS INSTALLED FOR CONTROL OF PRIMARY HEATING AND COOLING SYSTEMS
- CIRCULATION SYSTEMS HOT WATER SYSTEMS HAVE AUTOMATIC OR ACCESSIBLE MANUAL CONTROLS
- EXHAUST AND RANGE HOODS SHALL MEET THE EFFICIENCY REQUIREMENTS OF TABLE R403.6.1 OF THE IECC
- HVAC SYSTEM SHALL BE SIZED PER ACCA MANUAL J OR OTHER APPLICABLE METHOD
- HEATED WATER CIRCULATION SYSTEMS SHALL BE PROVIDED IN ACCORDANCE WITH SECTION R403.5.1. AUTOMATIC CONTROLS AND BE PROVIDED WITH A CIRCULATION PUMP TO MAINTAIN THE REGULATION PUMP CIRCUIT. SHALL LIMIT THE TEMPERATURE OF THE WATER ENTERING THE COLD WATER PIPING TO 104°F
- HVAC PIPING CONVEYING FLUIDS ABOVE 90°F OR CHILLED FLUIDS ABOVE 55°F ARE INSULATED TO BE INS-2.3 THE INSULATION SHALL BE PROTECTED PER SECTION R403.6 OF THE IECC
- HOT WATER PIPES ARE INSULATED TO R20-3
- 75% OF LAMPS IN PERMANENT FIXTURES OR 75% OF PERMANENT FIXTURES HAVE HIGH EFFICIENCY LAMPS PER SECTION 404.1 OF THE IECC
- ALL GLASS LIGHTING SYSTEMS SHALL BE ENERGY RATED FOR LIGHT
- MEP CONTRACTORS TO PROVIDE CONSTRUCTION DOCUMENTS IN COMPLIANCE WITH

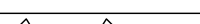


### THIRD FLOOR PLAN

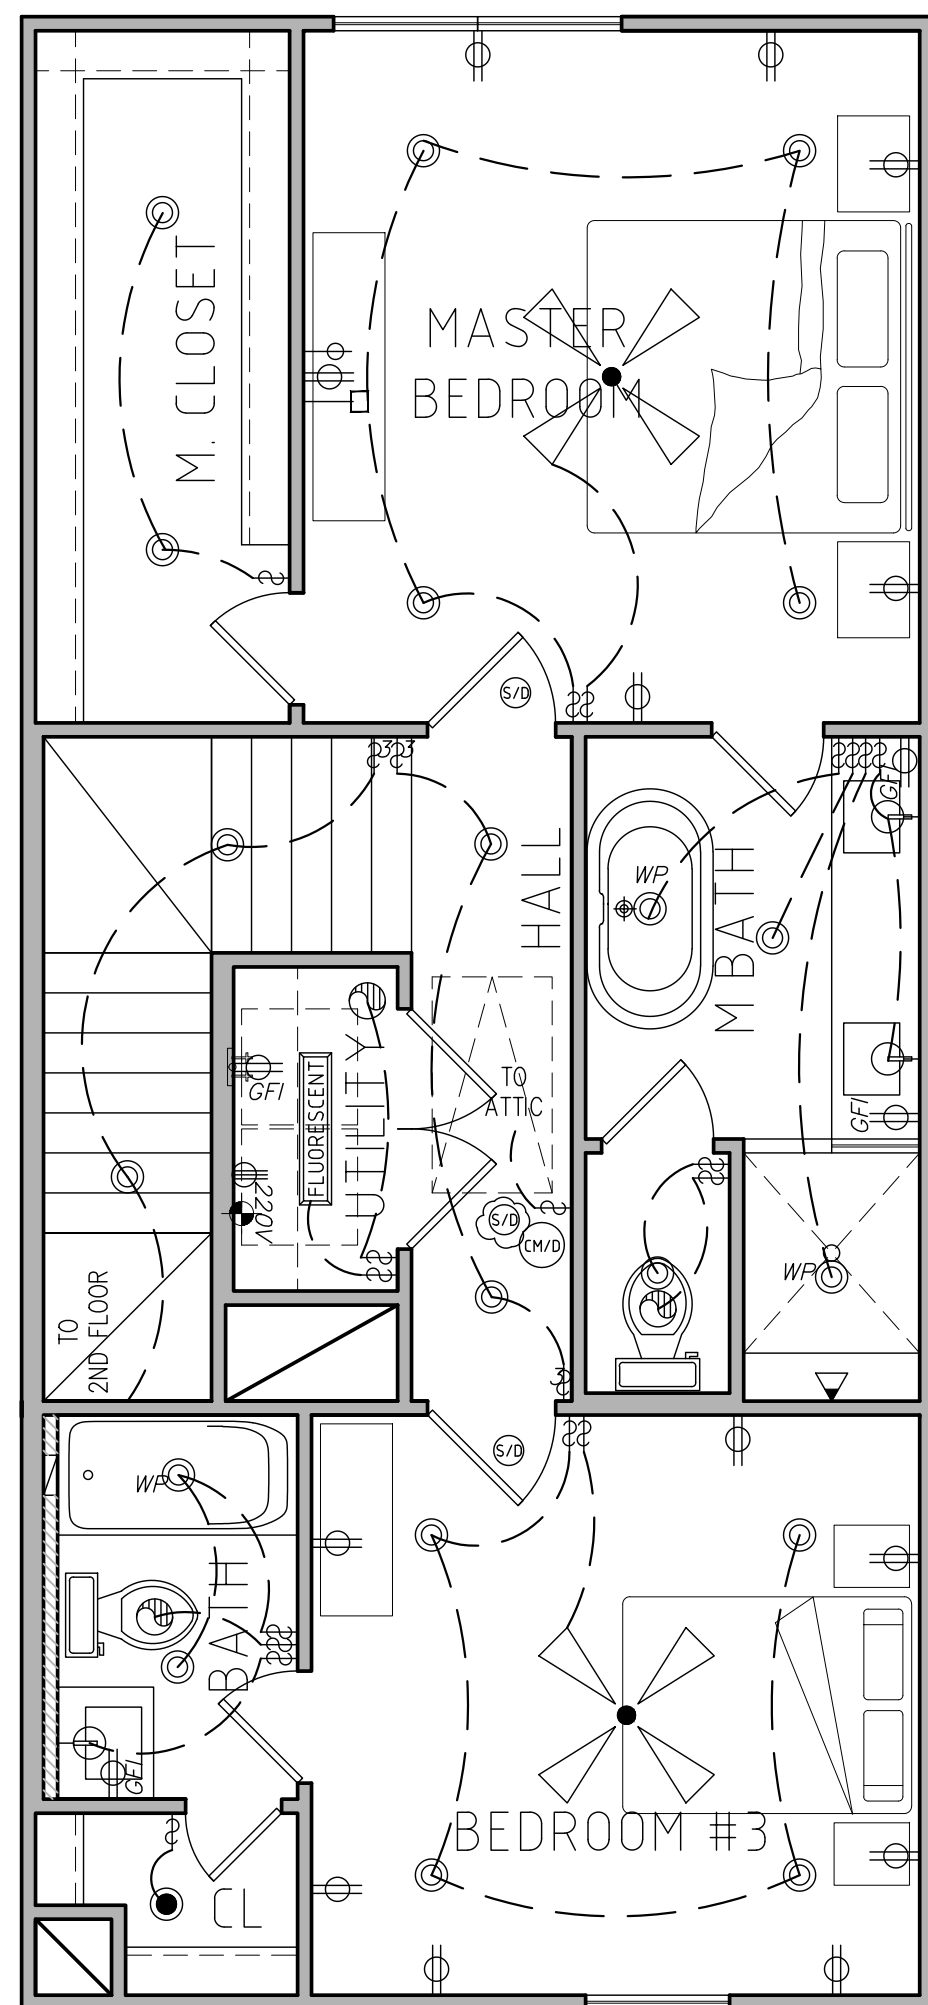Scale: 1/4"= 1'-0"

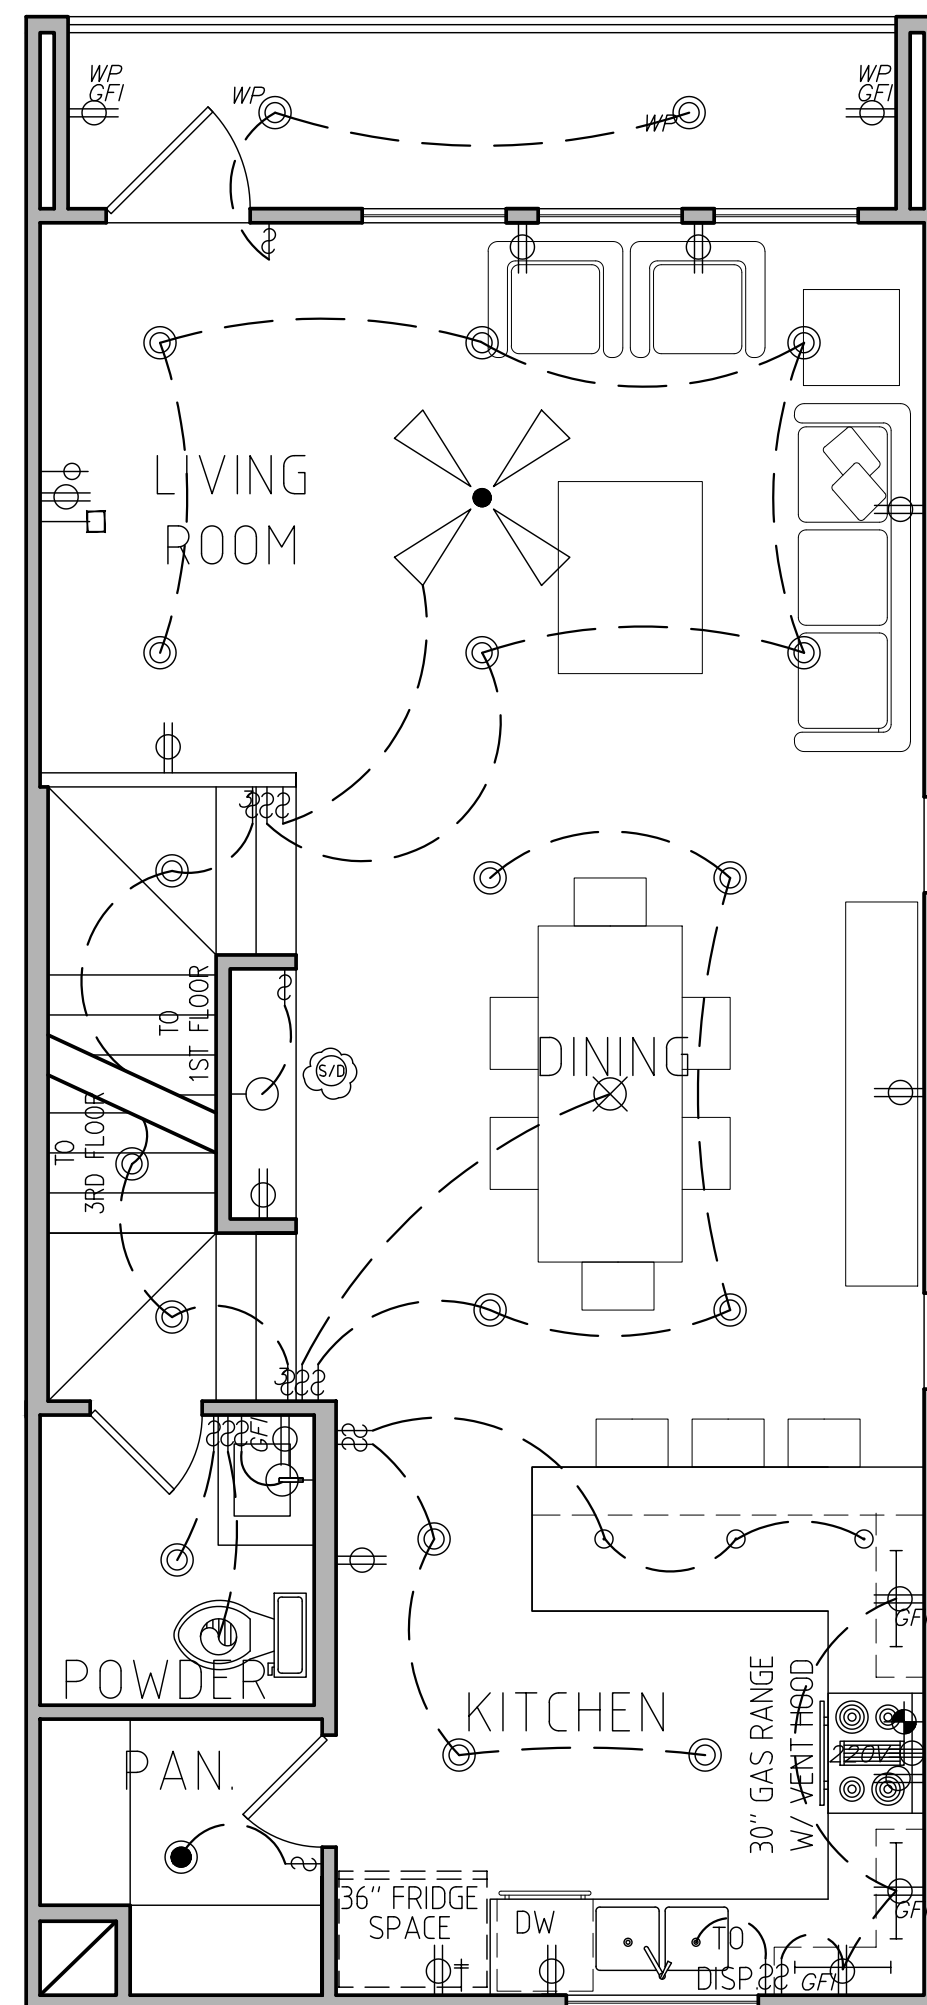

## SECOND FLOOR PLAN

Scale: 1/4" = 1'-0"

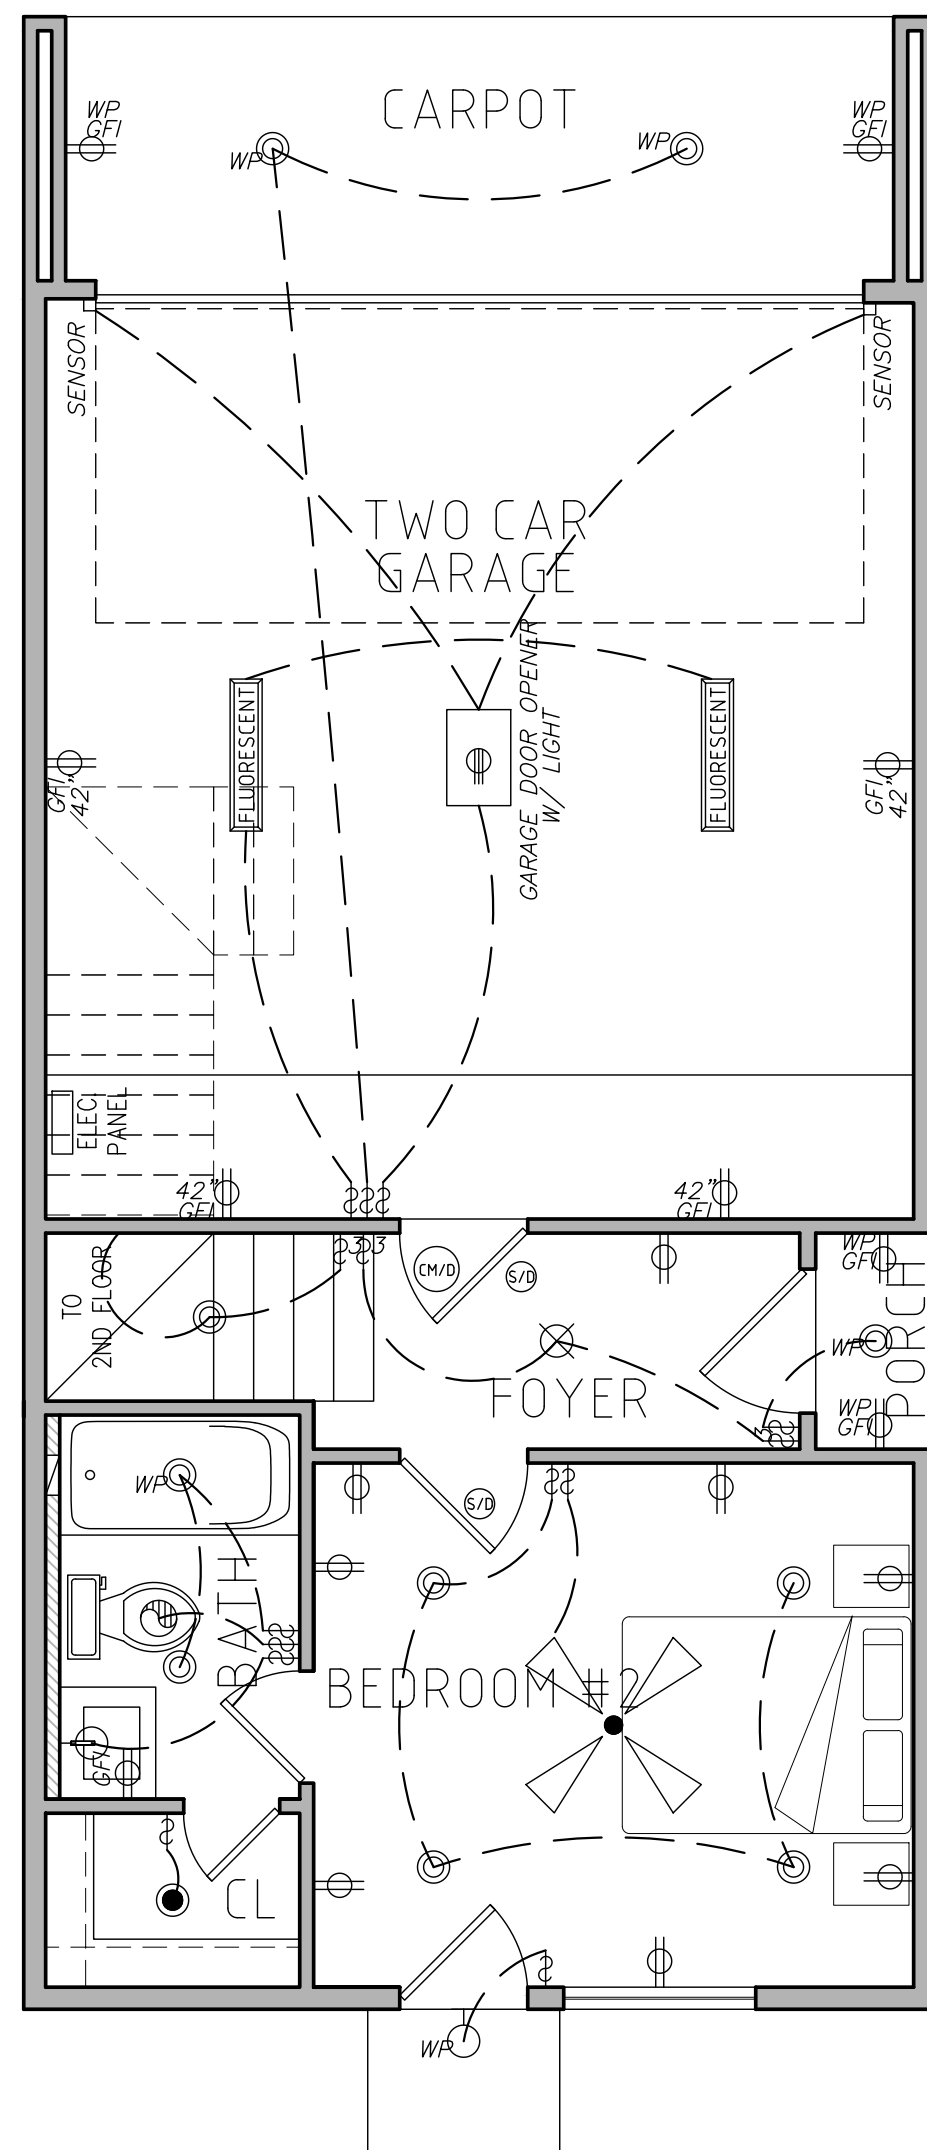

FIRST FLOOR PLAN  
Scale: 1/4"= 1'-0"

LANDING AT YALE  
316 B, 316 C, 316 D, 316 E, 316 F, 316 G &  
316 O THORNTON ROAD  
4605 A, 4605 G, 4605 H, 4605 I, 4605 J &  
4605 K YALE STREET  
HOUSTON, TEXAS.

SHEET TITLE

ELECTRICAL  
PLANS

SHEET NO.

E1.1